CITY OF WEST TORRENS



Notice of Panel Meeting

Notice is Hereby Given that a Meeting of the

COUNCIL ASSESSMENT PANEL

will be held in the George Robertson Room, Civic Centre 165 Sir Donald Bradman Drive, Hilton

on

TUESDAY, 9 NOVEMBER 2021 at 5.00pm

Hannah Bateman Assessment Manager

City of West Torrens Disclaimer

Council Assessment Panel

Please note that the contents of this Council Assessment Panel Agenda have yet to be considered and deliberated by the Council Assessment Panel therefore the recommendations may be adjusted or changed by the Council Assessment Panel in the process of making the <u>formal Council Assessment</u> Panel decision.

Note: The plans contained in this Agenda are subject to copyright and should not be copied without authorisation.

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- 1 MEETING OPENED
- 1.1 Acknowledgement of Country
- 1.2 Evacuation Procedures
- 2 PRESENT
- 3 APOLOGIES

4 CONFIRMATION OF MINUTES

RECOMMENDATION

That the Minutes of the meeting of the Council Assessment Panel held on 12 October 2021 be confirmed as a true and correct record.

5 DISCLOSURE STATEMENTS

In accordance with section 7 of the *Assessment Panel Members – Code of Conduct* the following information should be considered by Council Assessment Panel members prior to a meeting:

A member of a Council Assessment Panel who has a direct or indirect personal or pecuniary interest in a matter before the Council Assessment Panel (other than an indirect interest that exists in common with a substantial class of persons) –

- a. must, as soon as he or she becomes aware of his or her interest, disclose the nature and extent of the interest to the panel; and
- b. must not take part in any hearings conducted by the panel, or in any deliberations or decision of the panel, on the matter and must be absent from the meeting when any deliberations are taking place or decision is being made.

If an interest has been declared by any member of the panel, the Assessment Manager will record the nature of the interest in the minutes of meeting.

6 REPORTS OF THE ASSESSMENT MANAGER

6.1 TRANSITIONAL APPLICATIONS

6.1.1 5-9 Palmyra Avenue, TORRENSVILLE

Application No 211/279/2021

Appearing before the Panel will be:

Representor: Quy Phuoc Lam of 4 Rawlings Avenue, Torrensville wishes to appear in support

of the representation.

Applicant: Charles Thompson of New Creation Group wishes to appear in response to the

representation.

DEVELOPMENT APPLICATION DETAILS

DESCRIPTION OF DEVELOPMENT	Demolition of existing buildings and construction of 19, two-storey dwellings with common driveway access and associated landscaping
APPLICANT	New Creation Group
APPLICATION NUMBER	211/279/2021
LODGEMENT DATE	11 March 2021
ZONE	Urban Corridor Zone
POLICY AREA	Transit Living Policy Area 36
APPLICATION TYPE	Merit
PUBLIC NOTIFICATION	Category 2
REFERRALS	 Internal City Assets City Operations (Street Trees) Waste Management External Nil
DEVELOPMENT PLAN VERSION	Consolidated 21 May 2020
DELEGATION	The relevant application is for a merit, Category 2 or Category 3 form of development, representations have been received and one or more representors wish to be heard on their representation.
RECOMMENDATION	Support with reserved matter and conditions
REPORT AUTHOR	Brendan Fewster

BACKGROUND

The application was lodged prior to 19 March 2021 therefore subject to the transitional provisions in the *Planning, Development and Infrastructure Act 2016* (PDI Act) and to be assessed against the Development Plan in accordance with Regulation 11(2) of the *Planning, Development and Infrastructure (Transitional Provisions) Regulations 2017.*

SUBJECT LAND AND LOCALITY

The subject land comprises two contiguous allotments that is commonly known as 5-9 Palmyra Avenue, Torrensville. The land is formally described as:

- Allotment 42 in Filed Plan 144270 in the area named Torrensville Hundred of Adelaide, Volume 5720 Folio 72.
- Allotment 43 in Filed Plan 144271 in the area named Torrensville Hundred of Adelaide, Volume 5798 Folio 608.

The subject site is regular in shape with a frontage of 57.73 metres (m), a depth of up to 66.29m and a total site area of approximately 3550 square metres (m²).

It is noted that there are no easements, encumbrances or Land Management Agreements on the Certificate of Title.

The site contains a large single storey building that is currently occupied as a dwelling having previously been used as a hostel. While the building appears to have been built in the early 1900's and exhibits historical features, the building is not identified in the Development Plan has having heritage status. There are also several outbuildings and a bitumen car parking area adjacent to the Palmyra Avenue frontage.

The land is naturally flat with and there are no Regulated trees on the site or on adjoining land that would be affected by the development.

The locality comprises an established residential area that interfaces with several commercial uses immediately to the north along Henley Beach Road. These commercial uses include small-scale offices and shops. Residential development on the northern side of Palmyra Avenue, which is situated within the Urban Corridor Zone comprises predominately detached and semi-detached dwellings. Land on the southern side of Palmyra Avenue is within the Cowandilla / Mile End West Character Policy Area of Residential Zone and is generally characterised by single storey villa and bungalow dwellings at low densities.

While the amenity in the vicinity of Palmyra Avenue is relatively high, the northern side of the subject land and surrounding properties are exposed to commercial buildings and traffic noise along Henley Beach Road, which have significant amenity impacts.

The subject land and locality are shown on the aerial imagery below.



RELEVANT APPLICATIONS

DA Number	Description of Development	Decision	Decision Date
211/564/2017	Demolition of single storey dwelling and associated structures	Approved	30/05/2017
211/214/2017	Construct five two and three storey residential flat buildings comprising 24 dwellings	Refused (non-supply of information)	09/10/2017
211/1179/14	Change of use from hostel to dwelling	Approved	22/07/2015

PROPOSAL

The application is for the construction of 19, two-storey 'group' dwellings with common driveway access and associated landscaping and fencing. The dwellings are designed in groups of four with wall to wall construction.

The dwellings have a linear layout with a common architectural style and form. The building design is modern, incorporating relatively simple facades that include flat roofs behind parapet walls, front fenestration, balconies to dwellings fronting the road and contrasting materials. External materials include horizontal Scyon Stria panels and rendered Hebel cladding (surfmist), glass balustrades and aluminium frame windows and doors (black).

The dwellings fronting Palmyra Avenue are setback a minimum of 3 metres from the road boundary while the rear dwellings are setback 4.0 metres from the northern (rear) boundary.

All dwellings will be accessed via a new common driveway that is located at the western end of the road frontage. A screened bin store will be located adjacent to a central garden area and a mix of landscaping is to be provided along the road frontage and perimeter boundaries, within courtyards and alongside the common driveway.

All existing buildings on the site are to be demolished.

The relevant plans and documents are contained in **Attachment 2**.

PUBLIC NOTIFICATION

The application is a Category 2 form of development pursuant to Schedule 9 of the *Development Regulations 2008.*

Properties notified	38 properties (owners and occupiers) were notified during the public notification process.	
Representations	Two (2) representations were received, with one representation subsequently withdrawn.	
Persons wishing to be	One (1) representor wishes to be heard.	
heard	Quy Phuoc Lam of 4 Rawlings Avenue, Torrensville	
Summary of	Concerns were raised regarding the following matters:	
representations	Loss of privacy	
Applicant's response to	Summary of applicant's response:	
representations	 Dwellings 1 to 8 have been designed to front the road; 	
	Based on the floor height and angle, overlooking would not be possible to 4 Rawlings Avenue.	

A copy of the representations and the applicant's response is contained in **Attachment 3**.

INTERNAL REFERRALS

Department	Comments
City Assets	The FFL's of the proposed development (99.60 minimum) have been assessed as satisfying minimum requirements (99.38) in consideration of street and/or flood level information.
	Stormwater connection is in direct conflict with the common crossover servicing multiple dwellings at the rear.
	 The stormwater connection for Residence 5 and Residence 7 should be relocated to ensure that 2m offset from existing street tree.
	The shape and material of stormwater connection has been assessed as satisfying minimum requirements.
	The resident parking requirement would be satisfied by the provision of 2 garage spaces per dwelling. However there would be a parking shortfall of 4 to 5 spaces for visitor parking. It would be desirable, in my opinion, to provide 2 visitor spaces within the site. This would result in some loss of landscaping in the central garden area. The remaining visitor parking demand can be suitably accommodated by on-street parking.
	The 10 bike parking racks shown around the central garden area would satisfy the Development Plan requirement.
	Concerns relating to vehicle manoeuvrability and width of garage openings.
	It is recommended that the width of the crossover servicing multiple unit is 5.5m with 0.3m flaring on each side (6.1m wide at the kerb line).
	Letter boxes and services are currently located outside the driveway passing area.
	The internal garage length is currently proposed as 5.6m. Although not specified in the relevant Australian Standards (AS/NZS 2890.1:2004), traffic engineering best practice guides that the minimum internal length of an enclosed garage or enclosed carport space should be a minimum of 5.8m.
	The applicant has chosen to adopt the 'Alternate' approach for desired stormwater management for this site.
	Stormwater quality for the site has been considered as satisfying requirements.
	Initial concerns raised by City Assets have been resolved by way of amendments and imposition of appropriate conditions of consent.

City Operations (Street Trees)	As a result of the proposed crossover for the development at 5 Palmyra Avenue, City Operations has considered the health, structure, form, useful life expectancy and age of the street tree and in this instance will support the removal.
Waste Management	The proposed development at 5 and 7-9 Palmyra Avenue, Torrensville exceeds the maximum number of bins (10) for a standard or shared Council waste service. The proposal outlined by MFY Pty Ltd meets the requirements for waste provision to residential dwellings through a commercial waste company.

A copy of the relevant referral responses is contained in **Attachment 4**.

RELEVANT DEVELOPMENT PLAN PROVISIONS

The subject land is located within the Urban Corridor Zone and, more specifically, is within Transit Living Policy Area 36 as described in the West Torrens Council Development Plan.

The relevant Desired Character statements are as follows:

Urban Corridor Zone - Desired Character:

This zone will contain an innovative mix of medium density (45-70 dwellings per hectare) and high density (70-200 dwellings per hectare) residential development, together with community and employment land uses, along the Port Road, Anzac Highway, Richmond Road and Henley Beach Road corridors. The combination of land uses will vary within these corridors. Some locations will contain a genuine land use mix with ground floor shops, restaurants and offices, and upper level residential, while other areas will give primacy to residential development. Other parts of the zone will have a strong employment focus.

The function of main roads in the zone, particularly Port Road, Richmond Road and Anzac Highway, as major transport corridors will be protected by providing access to allotments from secondary road frontages and rear access ways as much as possible. Parking areas will be consolidated, shared (where possible) and screened from the street or public spaces. Allotments with car parking fronting Port Road, Anzac Highway, Richmond Road and Henley Beach Road will be redeveloped with built form closer to the road and reconfigured car parking areas.

As one of the key zones in the City of West Torrens where there will be transformation in built form, new buildings will be recognised for their design excellence. These buildings will establish an interesting pedestrian environment and human-scale at ground level through careful building articulation and fenestration, verandas, balconies, canopies and landscaping. In general, the greatest height, mass and intensity of development will be focussed at the main road frontage. Buildings of 3 or more storeys will be the predominant built form. It is for these reasons that dwellings other than detached dwellings will be the predominant form of residential development.

Overlooking, overshadowing and noise impacts will be moderated through careful design. Impacts on adjoining zones where development is lower in scale and intensity will be minimised through transition of building heights and setbacks, judicious design and location of windows and balconies, and the use of landscaping. The transition of building heights and setbacks, and judicious design is especially important adjacent Character Policy Areas, including those Character Policy Areas at Glandore and Ashford. The use of blank walls in these transitional areas, especially at the rear and side of allotments, will be avoided. Plant and service equipment will be enclosed and screened from view from the street and neighbouring allotments.

Where buildings are set back from main roads, landscaping will contribute to a pleasant pedestrian environment and provide an attractive transition between the public and private realm. Large scale development in the zone will facilitate the establishment of areas of communal and public open space, and create links with existing movement patterns and destinations in the zone. Front fencing in the zone will be kept low and/or visually permeable.

Some parts of the zone, including allotments in Thebarton and Keswick, are potentially contaminated because of previous and current industrial activities. In these circumstances, development is expected to occur on a precautionary basis if site contamination investigations identify potential site contamination, particularly where it involves sensitive uses such residential development.

The Thebarton brewery has potential to cause nuisance to future users and residents within this zone through noise and odour. To mitigate potential adverse impacts, residential development north of Smith Street that is likely to be sensitive to brewery operations should generally be avoided unless interface mitigation measures have been implemented (or will be implemented within an acceptable period) such that the anticipated impacts are within acceptable limits. Noise and air amenity with the zone is not expected to be equivalent to that expected from living in a purely residential zone.

Transit Living Policy Area 36 - Desired Character:

The policy area will contain primarily medium density residential development, together with some local shops, offices and community land uses to support the daily needs of residents. Larger retail formats may be appropriate on prominent or large-scale sites where proposed as part of a coordinated, mixed-use development with a residential focus. This includes the former TAFE site bound by Richmond Road, Sutton Terrace and Desmond Avenue at Marleston. There will be a variety of building forms and design, creating housing opportunity for people of various life stages and accommodating a variety of small businesses that do not compromise residential amenity.

Development will take place at medium densities. This will result in the replacement of existing detached dwellings at low to very low density with row dwellings and residential flat buildings, possibly involving allotment amalgamation. Vehicle access will occur from side streets and new rear laneways where possible.

Safe and efficient pedestrian movement along arterial roads and associated transport networks and facilities will be supported by limiting vehicle access points to allotments from side streets and new rear laneways where possible. This will also support the retention/planting of street trees on arterial roads.

New buildings will contribute to a highly varied built streetscape, allowing multiple built form design responses that support innovative housing and mixed-use development. Buildings in the part of the policy area around Henley Beach Road will be up to 3 storeys west of Marion Road and 4 storeys east of Marion Road. Buildings in the part of the policy area along Richmond Road will be up to 6 storeys in height toward Richmond Road, transitioning down in height to provide a 2 to 3 storey building interface toward adjacent residential areas and local streets. Balconies and windows will face the street to provide passive surveillance. Parking and garages will be located behind the front façade of buildings. State heritage places and Local heritage places will be adapted, maintaining their heritage qualities with redevelopment occurring to the rear and behind the front facades. Buildings adjacent to these heritage buildings will contain design elements and building materials that are complementary to such buildings.

Development will be interspersed with landscaping, particularly behind the main street frontage, to soften the appearance of buildings from the street and reduce heat load in summer.

Additional provisions of the Development Plan which relate to the proposed development are contained in **Attachment 1**.

QUANTITATIVE STANDARDS

The proposal is assessed for consistency with the quantitative requirements of the Development Plan as outlined in the table below:

DEVELOPMENT PLAN PROVISIONS	STANDARD	ASSESSMENT
NET RESIDENTIAL DENSITY Urban Corridor Zone PDC 5	45 dwellings per hectare (minimum)	54 dwellings per hectare Satisfies
PRIMARY STREET SETBACK Urban Corridor Zone PDC 17	Minimum setback where frontage is to Port Road, Anzac Highway or Henley Beach Road - No minimum at Port Road - 3m at Anzac Highway All other cases - 3m	3.0m Satisfies
SIDE SETBACK Urban Corridor Zone PDC 19	Side Frontage width 20m or less - no minimum up to 2 storeys and 3m above this height Frontage width >20m - 3m	0m – 8.1m Does not satisfy
REAR SETBACK Urban Corridor Zone PDC 19	0m (no minimum)	4.0m Satisfies
STORAGE Residential Development PDC 31	8m³ (min.)	Approx. 8m³ (under stairs, linen, WIR) Satisfies
BUILDING HEIGHT Urban Corridor Zone PDC 13	6 storeys and up to 24.5 metres	2 storeys or 7.6m Satisfies

CARPARKING SPACES Urban Corridor Zone PDC 20	Residential Development (+ an additional 0.25 spaces per dwelling for visitors) - 0.25 spaces per studio (no separate bedroom) - 1.0 space per 1 bedroom dwelling - 1.5 space per 2 bedroom dwelling - 2.0 spaces per 3+bedroom dwelling	2 spaces provided per dwelling 2 shared visitor spaces Does not satisfies (2 visitor space shortfall)
BICYCLE PARKING WeTo/7 Off-street Bicycle Parking Requirements for Designated Areas	Employee / resident = 1 for every 4 dwellings Visitor / shopper = 1 for every 10 dwellings	10 rails Satisfies
LANDSCAPING Medium and High Rise Development (3 or more stories) PDC 23	Deep soil areas (min) <300m² = 10m² with a min dimension of 1.5m 300 - 1500m² = 7% site area with a min dimension of 3m	Satisfies

ASSESSMENT

In assessing the merits or otherwise of the application, the proposed development is discussed under the following sub headings:

Form of Development and Desired Character

The subject land is situated within Transit Living Policy Area 36 of the Urban Corridor Zone. Objective 1 of the Policy Area envisages the following:

"A medium density residential area supported by local shops, offices and community land uses".

This Objective is supported by the Desired Character by encouraging the amalgamation of allotments and the replacement of existing detached dwellings with alterative dwellings types, such as group dwellings and residential flat buildings.

The proposal is an orderly and desirable form of development as it comprises the amalgamation of two existing allotments and the construction of group dwellings at medium densities.

Residential Density

PDC 5 of the Urban Corridor Zone is seeking a minimum net residential density of 45 dwellings per hectare for developments within Transit Living Policy Area 36.

As the subject land has a total area of approximately 3550m², the 'net' residential density of the development has been calculated at 54 dwellings per hectare. The proposed development is therefore within the medium density range and satisfies PDC 5.

As considered in more detail below, the proposed density of the development would not compromise the spatial and functional characteristics of the development and in particularly the built form relationship with the street and adjoining properties, on-site car parking and vehicle manoeuvrability or the internal amenity for future occupants. It is noted that buildings up to 6 storeys in height are envisaged in this part of the Policy Area.

Accordingly, the proposed density is within the desired range for the Zone and Policy Area, which are expressly seeking medium density residential development.

Design, Scale and Appearance

The Development Plan provisions promote contemporary and innovative building designs. New development that "contribute to a highly varied built streetscape, allowing multiple built form design responses" is desirable within the Zone and Policy Area.

The building design is modern, incorporating relatively simple facades that include flat roofs behind parapet walls, front fenestration, balconies to dwellings fronting the road and contrasting materials. External materials include horizontal Scyon Stria panels and rendered Hebel cladding (surfmist), glass balustrades and aluminium frame windows and doors (black). While there is some building repetition, the street-facing facades of Dwellings 1 to 8 are reasonably-well articulated with balconies and horizontal cladding and are complemented by quality landscaping and low openstyle fencing. All other dwellings (i.e. Dwellings 9 to 19) are situated toward the rear and will not be readily visible from the street.

The dwelling façades include windows to both the ground and upper floors that facilitate passive surveillance of the internal driveway and adjacent footpath while the dwelling entrances are readily identifiable and accessible from the road frontage and vehicle parking areas.

The internal floor areas would provide functional living environments with living rooms having an outlook to either front or rear yards.

PDC 13 of the Urban Corridor Zone envisages building heights of up to six storeys or 24.5 metres within Transit Living Policy Area 36 as the subject land does not adjoin Henley Beach Road. The proposed building height of only two storeys or 7.6 metres is well within the recommended height range. Furthermore, the relevant provisions do not require development in the Urban Corridor Zone to reference or provide a transition to existing development within the adjacent residential zone.

The design and appearance of the proposal is of a satisfactory standard and when considered against the intent of the Urban Corridor Zone, the proposed two-storey scale would provide an appropriate transition between the adjacent Residential Zone and the Urban Corridor Zone. Objective 2 and 3 and PDC 2 of Transit Living Policy Area 36 and Objective 1 and PDC 1 of the General Section (Design and Appearance) are therefore satisfied.

Boundary Setbacks

As recommended by PDC 17 of the Urban Corridor Zone, new buildings should be setback a minimum of 3.0 metres from road boundaries. The main front wall of Dwellings 1 to 8 are setback appropriately at 3.0 metres.

For side boundary setbacks, PDC 19 of the Urban Corridor Zone recommends a setback of 3.0 metres for allotments with a frontage of 20 metres or more. The side boundary setbacks range between 0m and 2.0 metres. While Dwellings 8, 9, 12 and 17 are setback less than 3.0 metres, the resulting impact of the reduced setbacks would not be significant given that:

- Dwelling 8 and 9 are setback 2.0 metres from the easten side boundary, which is consistent with the typical setback requirement for a two-storey dwelling;
- The boundary wall of Dwelling 12 adjoining the rear car park of a commercial building:

- Dwelling 17 is located immediately adjacent to existing garages and the side wall of a two storey dwelling on the adjoining property; and
- The subject land has a north to south orientation and the proposed dwellings are not overly tall or bulky.

PDC 19 allows for no boundary setbacks from rear boundaries (i.e. boundary development). The rear boundary setbacks of 4.0 metres are therefore acceptable.

Vehicle Access and Car Parking

All dwellings will be accessed via a new common driveway that is located at the western end of the road frontage. City Operations has agreed to the removal of the existing street tree to accommodate the new crossover. A notation regarding the costs associated with the tree removal has been included. The access has been designed to achieve a pedestrian sight triangle between the driveway and Dwelling 1 to ensure safe traffic movements.

The applicant has amended the driveway and some garages following concerns raised by City Assets in relation to internal vehicle manoeuvrability.

Overall, the proposed access arrangements are considered safe and convenient in accordance with PDC 24 of the General Section (Transportation and Access).

In terms of on-site car parking, all proposed dwellings are provided with a double garage or carport, and two common visitor spaces will also be provided. PDC 20 of the Urban Corridor Zone requires car parking to be provided based on *Table WeTo/6 - Off-street Vehicle Parking Requirements for Designated Areas*. In Transit Living Policy Area 36, car parking should be provided as follows:

- 2.0 spaces per 3 + bedroom dwelling
- Plus 0.25 spaces per dwelling for visitors

Given that 19 dwellings are proposed, there is a shortfall of two visitor car parking spaces. While this shortfall is not ideal, Council's Traffic Engineer is satisfied that the "remaining visitor parking demand can be suitably accommodated by on-street parking. I note that the subject frontage of the site can satisfactorily accommodate 6 or more on-street parking spaces, as the 8 dwellings that front Palmyra Avenue are designed with rear garage access".

While additional on-site visitor parking could be provided within the common garden area, it is considered more appropriate in this instance to maintain the current amount of landscaping given the existing on-street parking availability.

Accordingly, there is considered to be sufficient on-site car parking to meet the anticipated demand generated by the proposed development. PDC 20 of the Urban Corridor Zone and PDC 34 of the General Section (Transportation and Access) have been satisfied.

Landscaping

The applicant has provided a detailed landscaping proposal that includes a mix of trees, shrubs and ground covers along the road frontage and perimeter boundaries, within courtyards and alongside the common driveway.

The proposed landscaping would equate to 10 per cent of the site, possibly more, which satisfies PDC 4 of the General Section (Landscaping, Fences and Walls). The landscaping would enhance the internal amenity and external appearance of the development, as well as minimising heat loads in accordance with PDC 1 and 4 of the General Section (Landscaping, Fences and Walls).

Private Open Space

The proposed dwellings will be provided with at least 26m² of private open space. The amount of private open space for each dwelling is considered to satisfy PDC 19 of the General Section (Residential Development). The rear yards generally achieve the minimum dimension guidelines and would also be accessible from a living area. Suitable private open space for entertaining, clothes drying and other domestic functions would therefore be provided for occupants of the proposed dwellings.

Overlooking

The representor at 4 Rawlings Avenue has raised concerns with overlooking from the front dwellings into the rear yard of their property. The upper storey windows and balconies of the front dwellings (Dwellings 1 to 8) would have direct views onto the street, with only oblique and distant views likely to affect 4 Rawlings Avenue. The separation distance is sufficient such that direct overlooking is not considered to be of concern.

All side and rear upper level windows will have fixed obscure glazing or raised sills to a height of at least 1.7 metres above the floor level. Internally, it is not considered necessary for the front windows of Dwellings 9 to 19 to have privacy treatments given the design and layout of the front dwellings.

The proposed privacy measures and siting of the dwellings would prevent 'direct' views from the upper storey windows and balconies into the habitable room windows and yards areas of adjoining properties. The proposal therefore satisfies PDC 27 of the General Section (Residential Development).

Overshadowing

Given the two storey scale of the proposed buildings, it is reasonable to expect that some shadow would be cast over the adjoining land to the south, particularly during winter months.

As the land has a north to south orientation, the most significant shadowing would occur over the adjacent road at the front of the site rather than affecting the adjoining properties. The habitable room windows and yard areas of the adjoining properties will continue to receive at least two hours of natural light during the day in winter, as required under PDC 11 of the General Section (Residential Development).

The proposal is therefore considered to satisfy PDC 10, 11 and 12 of the General Section (Residential Development).

Stormwater and Flood Management

Stormwater runoff from each dwelling will be directed to a 3,000L rainwater retention tank and plumbed into all toilets and the laundry. Overflow from the rainwater tanks and hard paved surfaces will be discharged to the street water table in accordance with Council's standard requirements. City Assets Department has confirmed that the proposed stormwater management system is acceptable.

Waste Storage and Collection

Council's Waste Management Department has confirmed that the development exceeds the maximum number of bins (10) for a standard or shared Council waste service and therefore a private waste contractor will be required. The proposed bin store is to be located adjacent to a central garden area and the waste collection arrangements outlined by MFY Pty Ltd are considered to meet the requirements for waste provision. Conditions of consent relating to the bin enclosure and odour management have been included.

The proposal is consistent with Objective 2 of the General Section (Waste).

SUMMARY

Having considered all the relevant Objectives and Principles of the Development Plan, the proposal is not considered to be seriously at variance with the Development Plan.

When balanced against the existing site and locality characteristics and the Desired Character for the Urban Corridor Zone and Transit Living Policy Area 36, the proposed residential development is considered to be an orderly and desirable form of development.

The building size and scale and the residential density is consistent with the Desired Character for the Zone and Policy Area and compatible with the changing pattern and built form characteristics of the locality. The design of the proposed development is of a satisfactory standard.

Vehicle access is considered safe and convenient and sufficient car parking is to be provided.

On balance, the proposed development sufficiently accords with the relevant provisions contained within the West Torrens Council Development Plan Consolidated 21 May 2020 and warrants Development Plan Consent subject to conditions.

RECOMMENDATION

The Council Assessment Panel, having considered all aspects of the report and the application for consent to carry out development of land resolves to GRANT Development Plan Consent for Application No. 211/279/2021 by New Creation Group to undertake the demolition of existing buildings and construction of 19, two-storey dwellings with common driveway access and associated landscaping and fencing at 5-9 Palmyra Avenue, Torrensville (CT5720/72 & 5798/608) subject to the following reserved matter and conditions of consent:

Reserved Matters:

The following information shall be submitted for further assessment and approval by the City of West Torrens as reserved matters under Section 33(3) of the *Development Act 1993*:

 A Construction Management Plan (CMP) for the proposed development. The CMP should identify potential issues and appropriate measures to minimise impacts and disruption to surrounding residents and business owners during the construction phase of the development. The plan shall also detail the types, volumes and distributions of traffic and how they will be managed.

Pursuant to Section 42(1) of the *Development Act 1993*, the Council reserves its decision on the form and substance of any further conditions of Development Plan Consent that it considers appropriate to impose in respect of the reserved matters outlined above.

Development Plan Consent Conditions:

- The development must be undertaken, completed and maintained in accordance with the plans and information detailed in this Application except where varied by any conditions listed below:
 - Demolition Plan prepared by New Creation Group, Sheet No. A101 dated 17/02/21;
 - Site Plan prepared by New Creation Group, Sheet No. A100 dated 12/07/21;
 - Landscape Plan & Schedule prepared by New Creation Group;
 - Units 1-8 Plans prepared by New Creation Group, Sheet No. A101-A109 dated 17/08/21;
 - Unit 9 Plans prepared by New Creation Group, Sheet No. A101-A109 dated 17/08/21;

- Units 10, 13-16 Plans prepared by New Creation Group, Sheet No. A101-A109 dated 17/08/21;
- Unit 11 Plans prepared by New Creation Group, Sheet No. A101-A109 dated 17/08/21;
- Unit 12 Plans prepared by New Creation Group, Sheet No. A101-A109 dated 17/08/21;
- Unit 12 Carport Plan prepared by New Creation Group, Sheet No. A101 dated 02/08/21;
- Unit 17 Plans prepared by New Creation Group, Sheet No. A101-A109 dated 17/08/21;
- Unit 17 Carport Plan prepared by New Creation Group, Sheet No. A101 dated 02/08/21;
- Unit 18 Plans prepared by New Creation Group, Sheet No. A101-A109 dated 17/08/21;
- Unit 19 Plans prepared by New Creation Group, Sheet No. A101-A109 dated 17/08/21;
- Front Streetscape Plan prepared by New Creation Group, Sheet No. A106 dated 01/11/21;
- Civil & Drainage Plan prepared by KP Squared, Drawing No. C2, Issue C dated 25/10/21;
- Earthworks & Paving Details prepared by KP Squared, Drawing No. C4, Issue A dated 10/02/21;
- Civil Details prepared by KP Squared, Drawing No. C5, Issue A dated 10/02/21;
- Stormwater Calculations prepared by KP Squared, Issue A dated 10/02/21; and
- Letter prepared by MFY dated 05/03/21.
- 2. All stormwater design and construction will be in accordance with Australian Standards and recognised engineering best practices to ensure that stormwater does not adversely affect any adjoining property or public road and, for this purpose, stormwater drainage will not at any time:
 - a) Result in the entry of water into a building; or
 - b) Affect the stability of a building; or
 - c) Create unhealthy or dangerous conditions on the site or within the building; or
 - d) Flow or discharge onto the land of an adjoining owner; or
 - e) Flow across footpaths or public ways.

Reason: To ensure that adequate provision is made for the collection and dispersal of stormwater

 All stormwater management measures for the development approved herein, including harvest tanks and supply mechanisms shall be installed and operational prior to the occupation of the development.

Reason: To ensure that adequate provision is made for the management of stormwater.

4. The rainwater tank for all dwellings shall be plumbed to deliver recycled water to all toilets and laundry cold water outlets and shall be connected prior to occupation of the dwellings.

Reason: To ensure that adequate provision is made for the collection and dispersal of stormwater

5. The stormwater connections for Dwellings 1 to 8 shall be offset a minimum of 2.0 metres from existing street trees that are to be retained.

Reason: To minimise impacts on existing street trees.

6. All driveways, parking and manoeuvring areas will be formed, surfaced with concrete, bitumen or paving, and be properly drained prior to occupation, and shall be maintained in reasonable condition at all times to the satisfaction of Council.

Reason: To ensure safe and convenient vehicle access and to supress dust

7. All landscaping shall be planted in accordance with the approved plans and incorporate an appropriate irrigation system within three (3) months of the occupancy of the development or the next available planting season. Any person(s) who have the benefit of this approval will cultivate, tend and nurture the landscaping and shall replace any plants which may become diseased or die.

Reason: To enhance the amenity of the site and locality and to mitigate against heat loading

8. The side and rear upper storey windows of all dwellings shall be fitted with fixed obscure glass to the windows and balcony balustrades to a minimum height of 1.7 metres above the upper floor level to minimise the potential for overlooking of adjoining properties, prior to occupation of the building. The glazing in these windows shall be maintained to the satisfaction of Council at all times.

Reason: To maintain the privacy of neighbouring residents

9. No aboveground structures, such as letterboxes, service meters or similar are to be installed within the common driveway entrance and passing area.

Reason: To ensure safe and convenient vehicle access

10. Details of the bin store enclosure shall be submitted to the satisfaction of Council prior to the issue of Development Approval.

Reason: To ensure minimal disturbance to surrounding properties and to maintain the amenity of the locality

11. The bin storage area shall be kept clean and tidy at all times with bins cleaned regularly to minimise odour.

Reason: To minimise odour and to maintain the amenity of neighbouring properties

12. Collection of waste shall be carried out at least once a week by a private contractor. All solid waste shall be stored in bins having a close fitting lid. The bins shall be stored within the designated bin storage area identified on the approved plans.

Reason: To ensure residence are provided with waste management facilities and to maintain the amenity of the locality.

NOTES

- City Operations has considered the health, structure, form, useful life expectancy and age of the street tree and in this instance will support the removal. Payment of a fee of \$750.00 will be required prior to the commencement of any work.
- The applicant is reminded that any boundary fencing, including a combination of retaining walls and fencing, that exceeds a height of 2.1 metres above ground level requires development approval under a separate application.


Attachments

- 1. Relevant Development Plan Provisions
- 2. Proposal Plans & Documentation
- 3. Representation & Applicants Response
- 4. Internal Referral Responses

Relevant Development Plan Provisions


General Section				
	Objectives	1		
Crime Prevention	Principles of Development Control	1, 2, 3, 6, 7& 8		
	Objectives	1 & 2		
Design and Appearance	Principles of Development Control	1, 2, 3, 4, 5, 9, 10, 12, 13, 14, 15, 16, 21, 22 & 23		
	Objectives	1 & 2		
Energy Efficiency	Principles of Development Control	1, 2 & 3		
	Objectives	1, 2, 3 & 4		
Land Division	Principles of Development Control	1, 2, 4, 5, 6 & 8		
	Objectives	1 & 2		
Landscaping, Fences and Walls	Principles of Development Control	1, 2, 3, 4, 6		
	Objectives	1, 2, 3, 4 & 5		
Orderly and Sustainable Development	Principles of Development Control	1& 3		
	Objectives	1, 2, 3, 4 & 5		
Residential Development	Principles of Development Control	1, 4, 5, 7, 8, 9, 10, 11, 12, 13, 14, 16, 18, 19, 20, 21, 22, 28, 30, 31, 32 & 33		
	Objectives	2		
Transportation and Access	Principles of Development Control	1, 2, 8, 9, 11, 23, 24, 30, 34, 35, 36, 37 & 44		

9 November 2021 Page 19

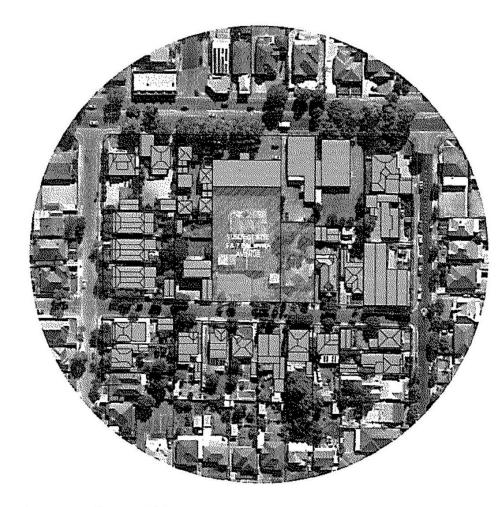

Location Plan

1:1000

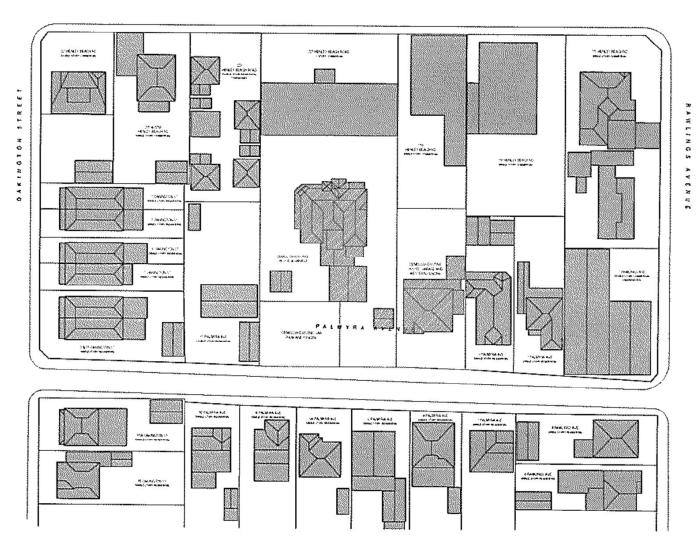

Demolition Plan

1:1000

Mrs Tania Russell 5-9 Palmyra Ave, Torrensville Palmyra Housing Development 17.02.21 Scale

1:1000

Sheet No.

A101

CONTRACTOR AND TO CONTRACTORS ARE TO VERIFY ALL DIMENSIONS ON SITE BEFORE COMMENCING ANY WORK, FIGURED DIMENSIONS SHALL TAKE PREDERENCE OVER SCALED DIMENSIONS AND ANY DISCREPANCY SHAIL I PE

Revision Date CONTRACTOR NOTE: NEW CREATION GROUP **BUILDING CONTRACTORS**

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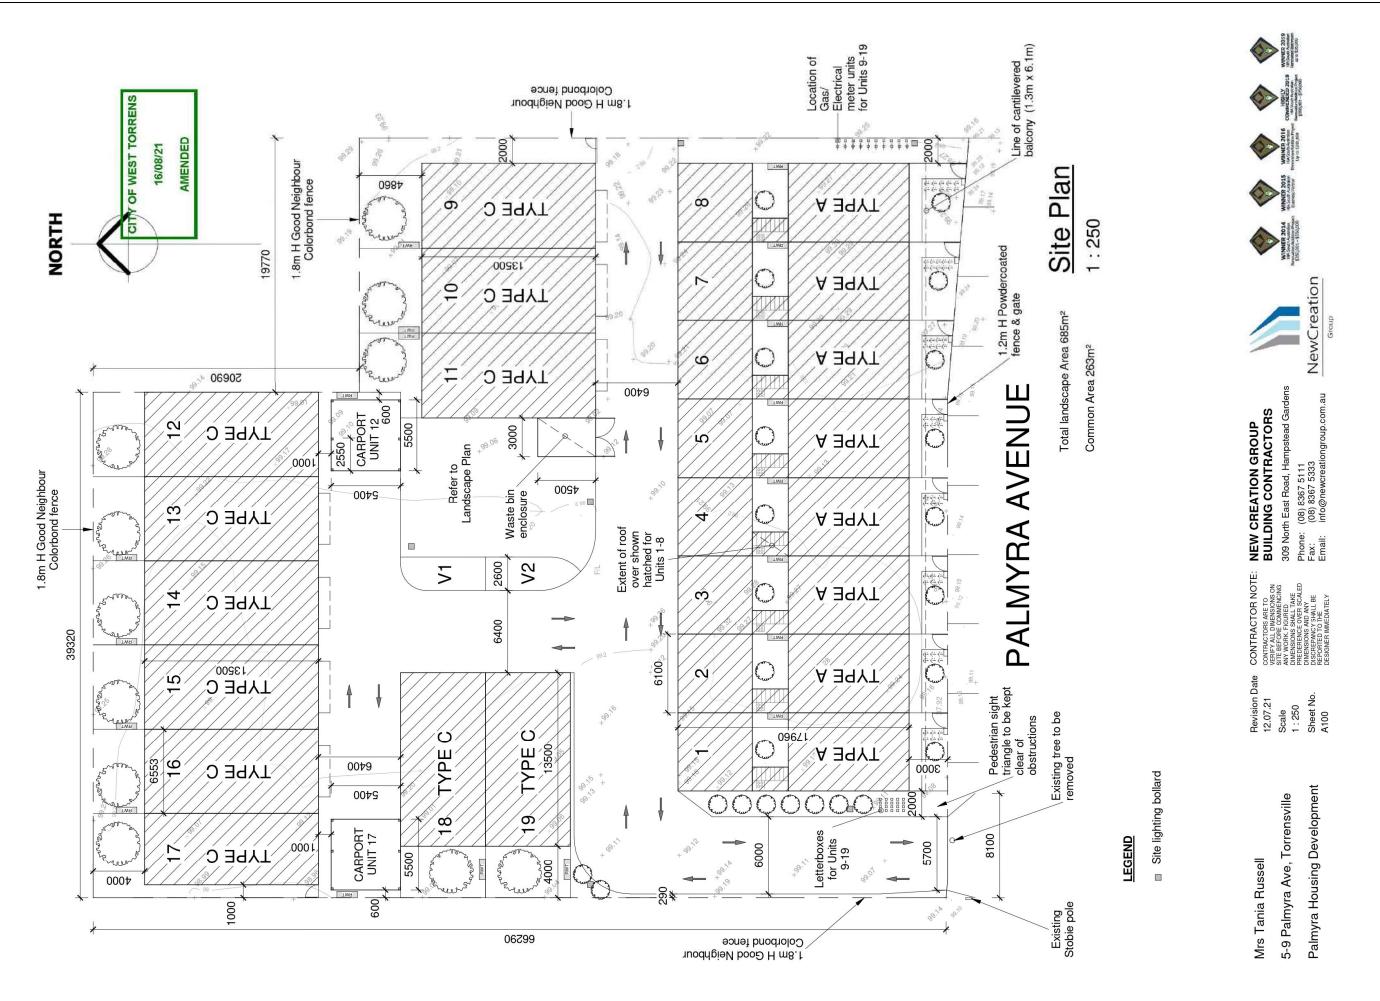









9 November 2021 Page 20 Council Assessment Panel



9 November 2021

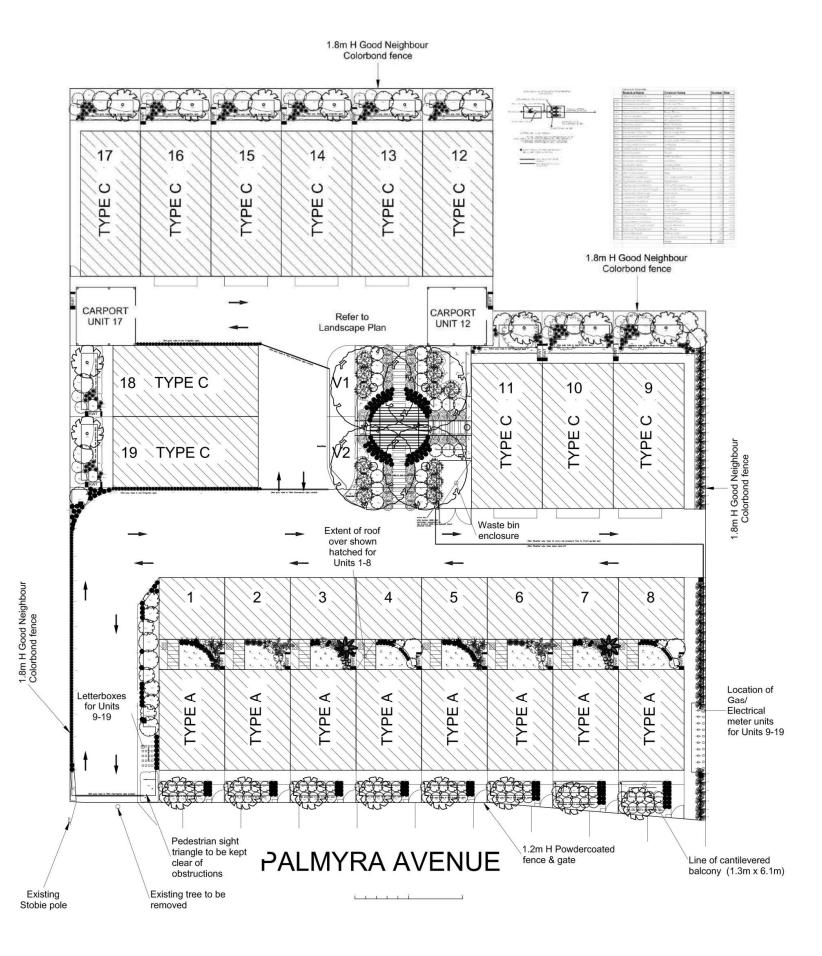

9 November 2021


Palmyra St Torrensville

	Botanical Name	Common Name	Number	Size
Aae	Adiantum aethiopicum	Maidenhair Fern	14	140
Abl	Asplenium bulbiferum	Birds Nest Fern	2	140
Abu	Anigozanthos 'Bush Gold'	Dwarf yellow Kangaroo Paw	120	140
Aca	Ajuga Çaitlin's Giant'	Bugle Flower	14	140
Ala	Acacía lanigera	woolly wattle	9	140
Alí	Alternanthera 'Little Ruby'	Alternanthera	40	140
Amo	Acanthus mollis	Bears Breeches	36	140
And	Alocasía odora	Elephants Ears	6	200
Bgi	Blechnum "Silver Lady"	Silver Lady Fern	12	140
Bsc	BergeniaxSchmidtii	Bergenia	14	140
Cfi	Corymbia ficifolia c.v.	Dwarf Grafted Flowering Gum	19	300
Cfr	Cordyline fruiticosa Rubra	Cordyline	6	140
cja	camellia Japonica	camellia	2	200
cmi	Clivia miniata	clivia	6	140
Dan	Dicksonia antarctica	Soft Tree Fern	2	200
Dma	Dracaena marginata	Dracaena	6	200
Dre	Dichondra repens	Kidney Weed	56	140
Eni	Eremophila nivea	Native Fuchsia	31	140
Hou	Hibbertia cuneiformis	cut Leaf Guinea Flower	16	140
Hma	Hydrangea macrophylla	Hydrangea	2	200
Hgo	Hymenosporum 'Gold Nugget'	Dwarf Native Frangipani	40	140
Lli	Lomandra 'Little Lime'	Matt Rush	131	140
Llo	Lomandra 'Lime Tuff'	lily Turf	327	140
Llt	Lomandra longifolia	Matt Rush	24	140
Lsí	Liriope 'Silver Lawn'	Lily Turf	36	140
Мра	Myoporum parvifolium	Creeping Boobialla	4	140

9 November 2021 Page 23

		Total	1218	
Wst	Wahlenbergia stricta	Australian Bluebell	14	140
vhe	Viola hederaceae	Native violet	20	140
Spu	Scaevola 'Purple Dancer'	Fan Flower	149	140
RCO	Raphiolepis 'Cosmic White'	Indian Hawthorn	40	140
PVi	Physostegia virginiana	Obedient Plant	2	140
Pve	Plectranthus verticillus	Swedish Ivy	6	140
Pli	Philodendron 'Little Phil'	Dwarf Philodendron	6	200
Nmo	Nandina 'Moonbay'	Dwarf Sacred Bamboo	6	200

9 November 2021 Page 24

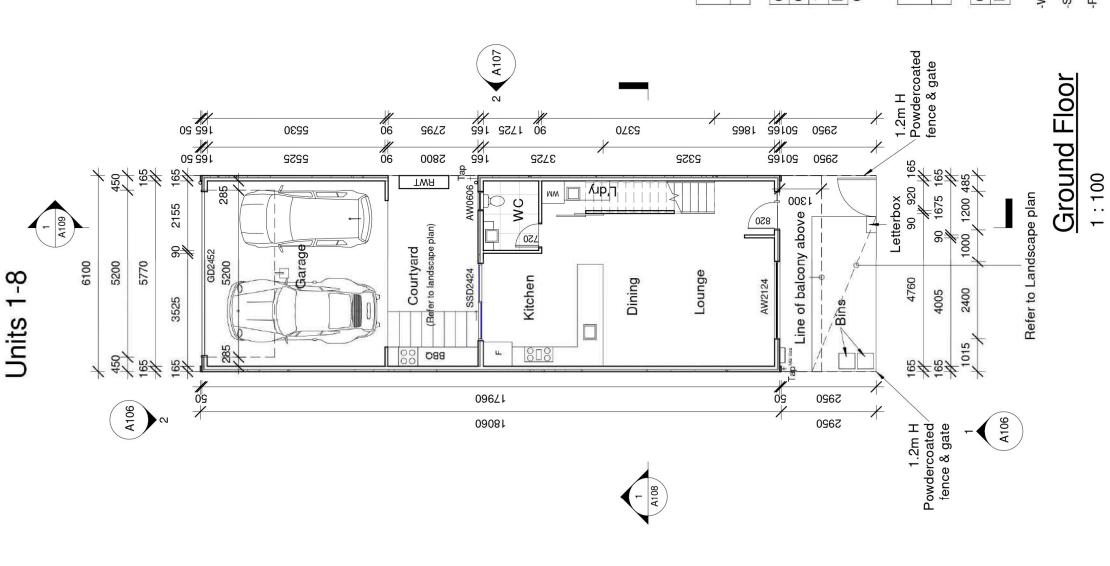

8.00 m² 198.28 m² 35.26 m² 57.22 m² 97.80 m² Area Schedule Carport
Ground Floor Living 5 Name Balcony Grand total

17.08 m² 18.30 m² Area Landscape Areas Courtyard Landscape Front Landscape Name

-Stair & balustrade to comply with part 3.9.2.1 of BCA -WC Door to be fitted with lift off hinges

-RWT Plumbed to WC & Laundry cold water tap

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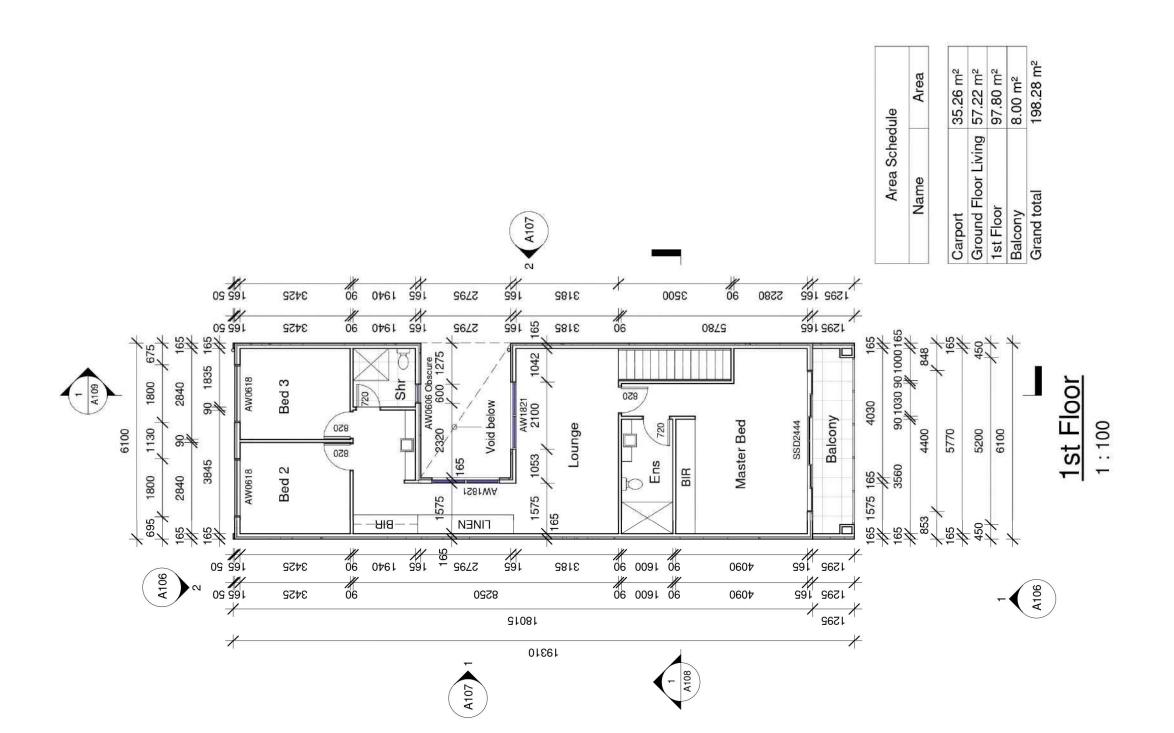
Revision Date 17.08.21 Scale 1:100 Sheet No. A101

Palmyra Housing Development 5-9 Palmyra Ave, Torrensville

Mrs Tania Russell

CONTRACTOR NOTE:

Page 25



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Revision Date 17.08.21 Scale 1:100 Sheet No. A102

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Page 26

TV Antenna









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Roof Plan 1:100

Revision Date 17.08.21 Scale 1:100 Sheet No. A103

Palmyra Housing Development


5-9 Palmyra Ave, Torrensville

Mrs Tania Russell

Page 27

tinU DA

Shr. Exhaust ©

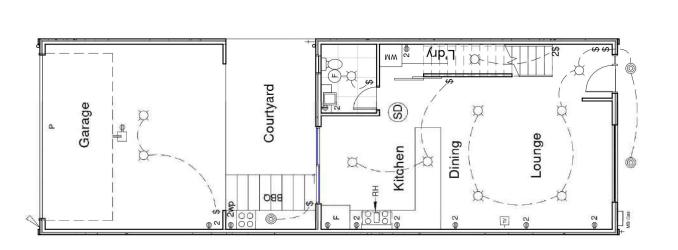

Electrical Legend

- Ceiling mounted smoke detector hard wired with battery back up
- LED Downlight

Ø

- 240 volt power outlet
- 240 volt double power outlet 2⊕
- Wall switch ↔
- Exhaust <u>ш</u>
- External Downlight 0
 - TV Point 2
- 240 volt double weather proof power outlet ⊕ 2wp
- Sensor light
- Rangehood Æ
- Meter/ Gas box MB/ Gas
- Automated Panel Lift Door Д

Ground Floor Electrical Layout

1:100

CONTRACTOR NOTE: Revision Date 17.08.21 Scale 1:100 Sheet No. A104

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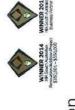
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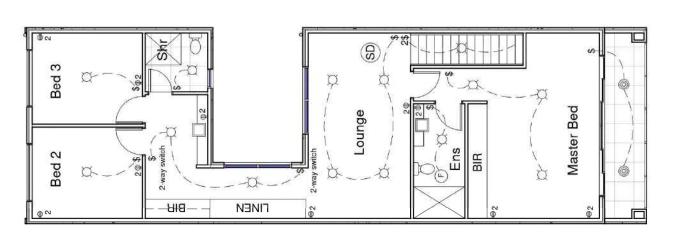












- Ceiling mounted smoke detector hard wired with battery back up
- LED Downlight

Ø

- 240 volt power outlet
- 240 volt double power outlet
- Wall switch
- 2 Way Wall Switch \$
- External LED Exhaust 0 (IL)

1st Floor Electrical Layout

1:100

CONTRACTOR NOTE: Revision Date 17.08.21 Scale 1:100 Sheet No. A105

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Palmyra Housing Development

5-9 Palmyra Ave, Torrensville

Mrs Tania Russell


BUILDING CONTRACTORS

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COLOUR SCHEDULE

Gliderol Hampton Surfmist Powder coated satin black Rev Roofing Surfmist Rev Roofing Surfmist Dulux Natural White Dowel Satin Black Dowel Satin Black Dowel Satin Black PGH Tribeca Red Surfmist or similar Traditional Single Dulux Monument Dulux Monument Dulux Surfmist Dulux Surfmist **Brighton Light** Satin Black Surfmist Surfmist Sectional Garage Door Windows Aluminium Fly Screen & Doors Framed Glass Balustrade Aluminium Sliding Doors Sectional Garage Door Front Fence (1.2m H) Aluminium Windows Face Brick Cladding Front Door Frame Grout Flush Joint Rainwater tank Render Finish Metal Fascia Eave Lining Downpipes Front Door Meter Box Roofing

LEGEND

1800

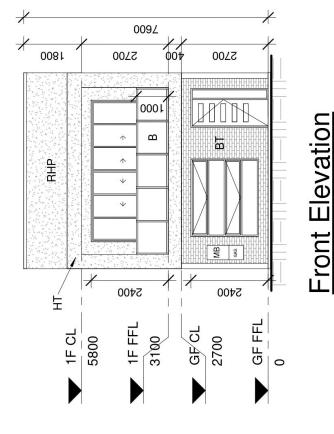H

1:100

Rendered 50mm Hebel Power Panel Cladding RHP

Scyon Stria Cladding

2.4m x 5.2m Panel Lift Door GD

Colourbond Roof @ 3° Pitch (min.) **E**

OB

5400

1F CL

5800

1F FFL

3100

 $\overline{\mathsf{M}}$

Brick Tile Cladding (PGH Tribeca) BT

Rendered Harditex Cladding 보

1m H Glass Framed Balustrade Obscure Glazing В

001 2700 2700 Elevation GD Rear 1:100

5400

10.45

2700

GF FFL

NEW CREATION GROUP BUILDING CONTRACTORS

CONTRACTOR NOTE:

Revision Date 17.08.21

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Scale
As indicated
Sheet No.
A106

Palmyra Housing Development

5-9 Palmyra Ave, Torrensville

Mrs Tania Russell












Page 30

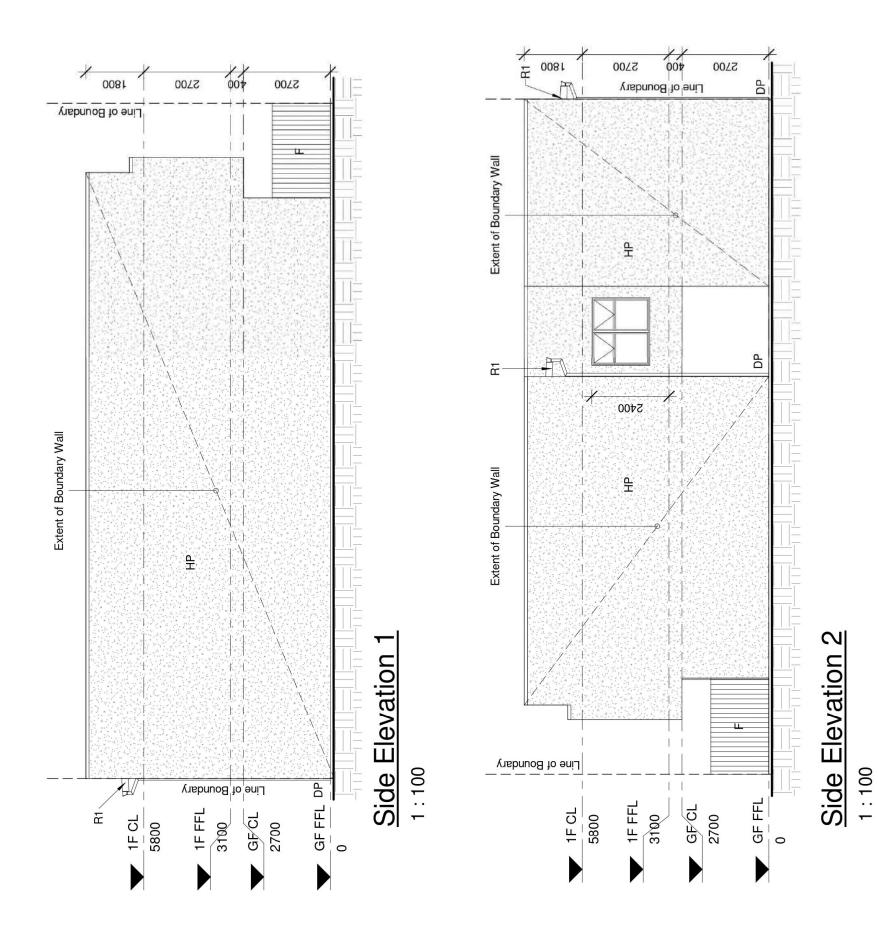

EXTERNAL FINISH SCHEDULE

1.8m H Good Neighbour Colorbond Internal parti fence. Colour: Woodland Grey or similar Rendered 50mm Hebel Power Panel Cladding RHP ш

Colourbond Roof @ 3° Pitch 50mm Hebel Power Panel Cladding

모 **E**

Gliderol Hampton Surfmist

Traditional Single

Sectional Garage Door Windows

Sectional Garage Door

Rev Roofing Surfmist Rev Roofing Surfmist

Dulux Natural White

Dowel Satin Black Dowel Satin Black

Aluminium Fly Screen & Doors

Eave Lining

Gutters

Aluminium Sliding Doors

Aluminium Windows

COLOUR SCHEDULE

Surfmist

Surfmist

PGH Tribeca Red

Face Brick Cladding Front Door Frame

Grout Flush Joint

Brighton Light

Dulux Monument Dulux Monument

COLOUR SCHEDULE

Front Door

Dowel Satin Black

Powder coated satin black

Satin Black

Framed Glass Balustrade

Meter Box

Dulux Surfmist Dulux Surfmist

Render Finish

Downpipes

Metal Fascia

Front Fence (1.2m H)

Rainwater tank

CONTRACTOR NOTE:

Revision Date 17.08.21 Scale As indicated Sheet No. A107

Palmyra Housing Development

5-9 Palmyra Ave, Torrensville


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Surfmist or similar

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Section 1

1:50

Screw fix internally

Boundary wall detail

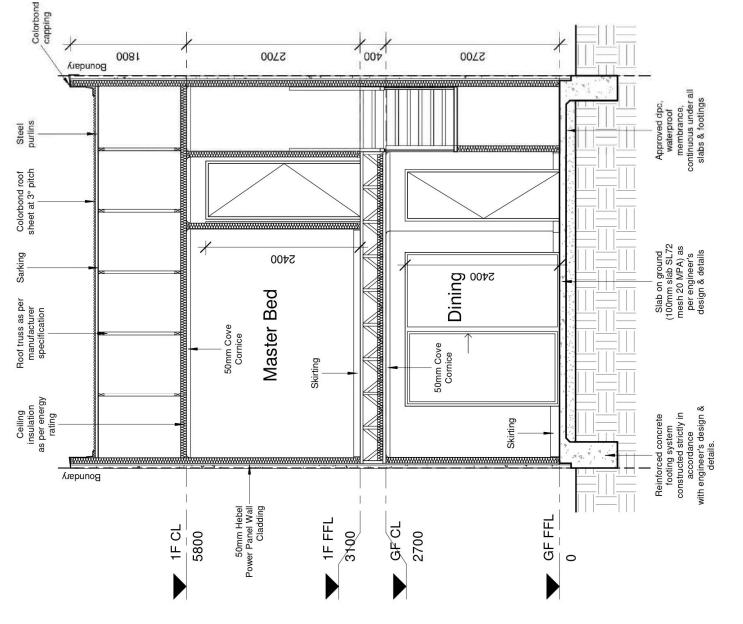50mm Power Panel Cladding

1:30

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Palmyra Housing Development 5-9 Palmyra Ave, Torrensville


Revision Date 17.08.21 Scale As indicated Sheet No. A108

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Section 2

1:50

Mrs Tania Russell

5-9 Palmyra Ave, Torrensville

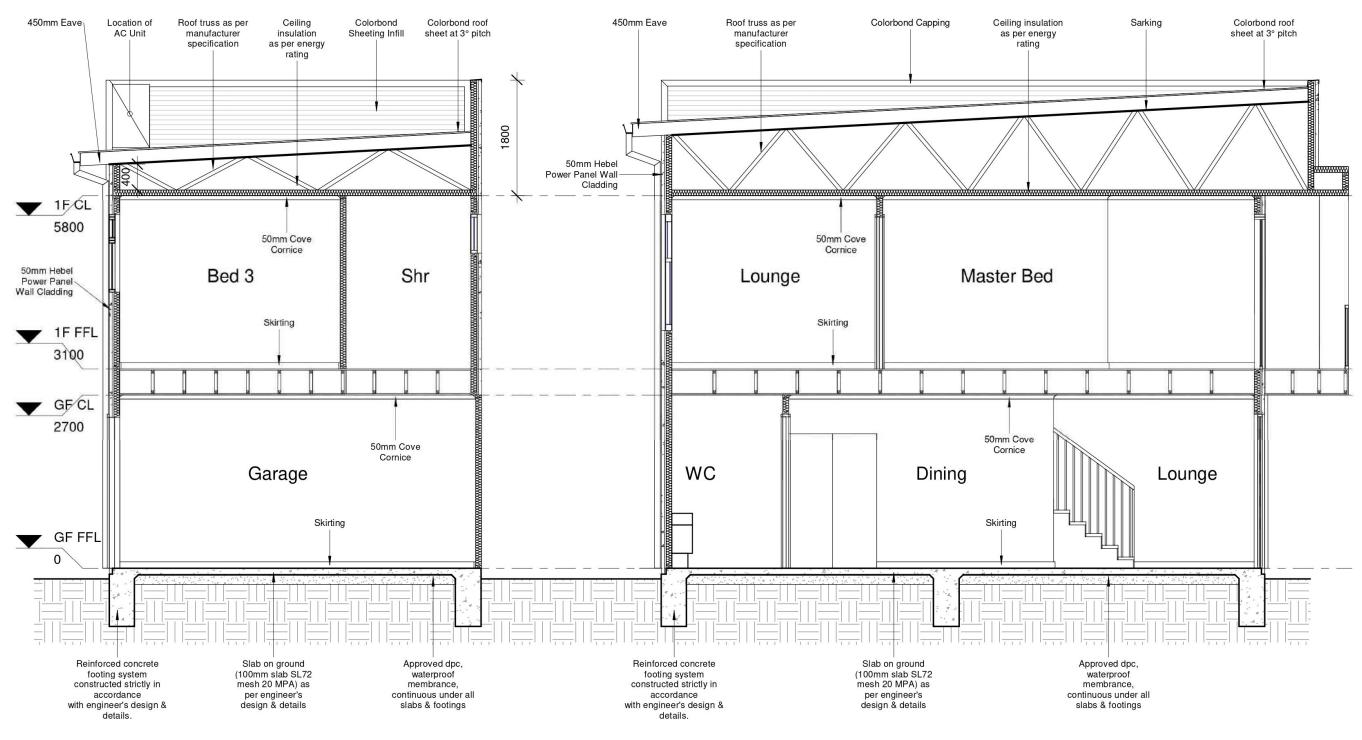Palmyra Housing Development

17.08.21 Scale

CONTRACTOR ARE TO CONTRACTORS ARE TO VERIEV ALL DIMENSIONS ON SITE BEFORE COMMENCING ANY WORK FIGURED DIMENSIONS SHALL TAKE PREDERENCE OVER SCALED DIMENSIONS AND ANY DISCREPANCY SHALL BE REPORTED TO THE DESIGNER IMMEDIATELY 1:50 Sheet No. A109

Revision Date CONTRACTOR NOTE: NEW CREATION GROUP **BUILDING CONTRACTORS**

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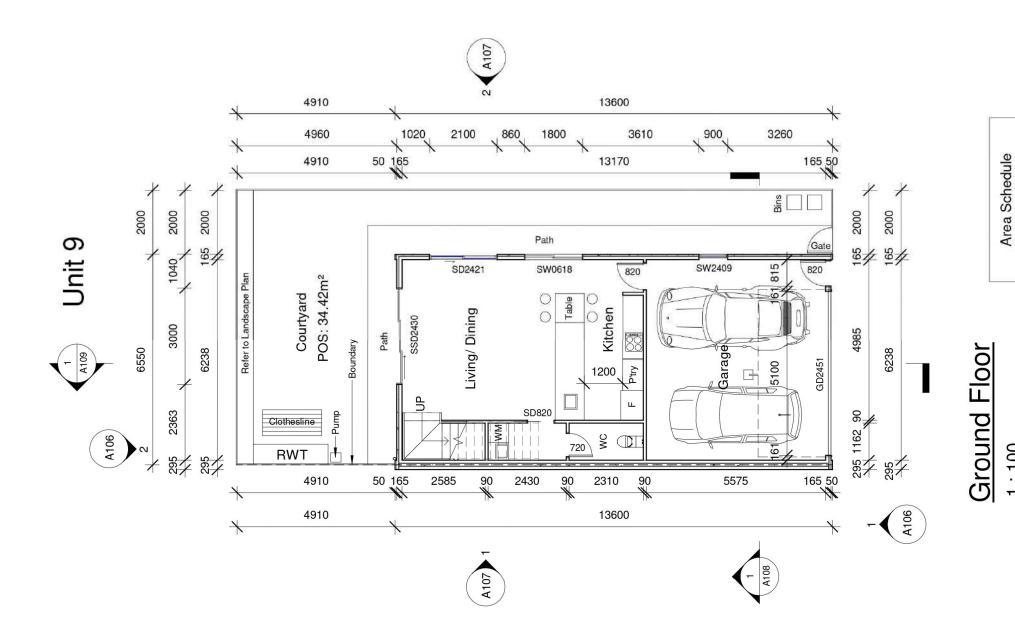









9 November 2021 Page 33



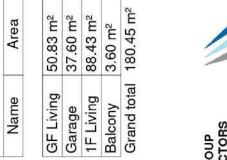

-Stair & balustrade to comply with part 3.9.2.1 of BCA

-WC Door to be fitted with lift off hinges

1:100

CONTRACTOR NOTE:

Revision Date 17.08.21 Scale 1:100 Sheet No. A101

CONTRACTORS ARE TO VEHEY ALL DIMENSIONS ON SITE BEFORE COMMENCING ANY WORK. FIGURED DIMENSIONS SHALL TAKE PREDERINCE OVER SCALED DIMENSIONS AND ANY DISCREPANCY SHALL BE REPORTED TO THE DESCRAMEN MARKEDATELY

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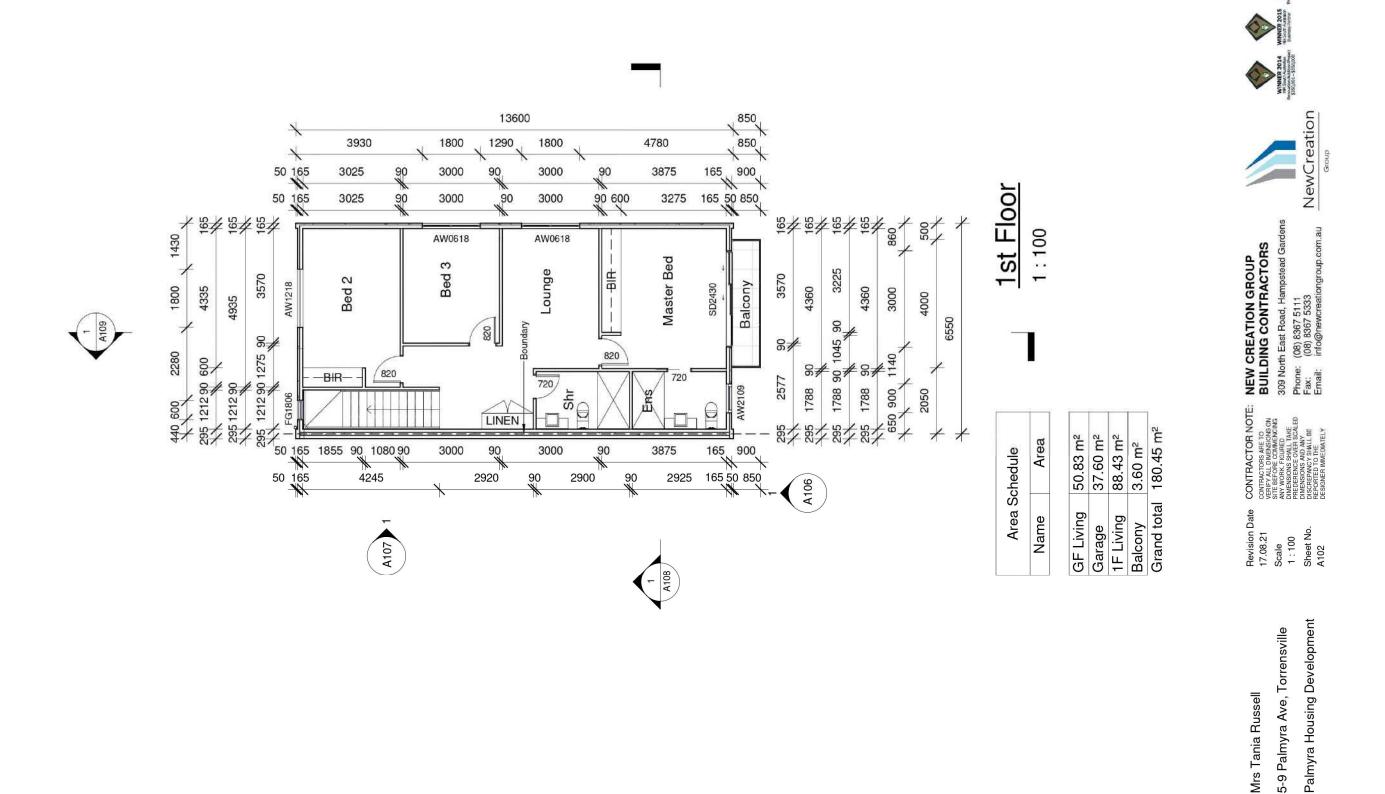
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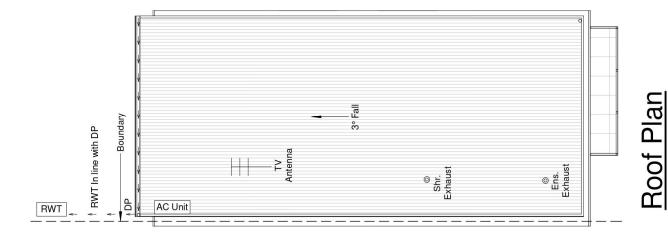


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9 November 2021 Page 35

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1:100

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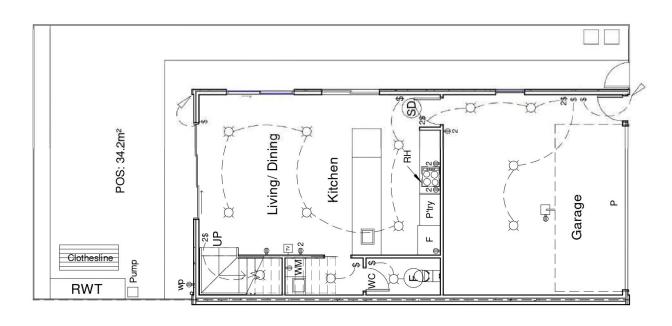
Revision Date 17.08.21 Scale 1:100 Sheet No. A103

Palmyra Housing Development

5-9 Palmyra Ave, Torrensville

Mrs Tania Russell

9 November 2021



Electrical Legend

- Ceiling mounted smoke detector hard wired with battery back up
- LED Downlight

Ø

- 240 volt power outlet
- 240 volt double power outlet
 - Wall switch
- Exhaust (IL)
 - 2
- 240 volt double weather proof power outlet TV Point dw ⊕
 - Automated Panel Lift Door Д
- Rangehood 표
- Sensor light

Ground Floor Electrical Layout

1:100



Revision Date 17.08.21 Scale 1:100 Sheet No. A104

Palmyra Housing Development 5-9 Palmyra Ave, Torrensville

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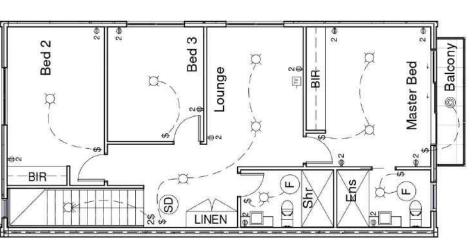












240 volt double power outlet

2⊕

Exhaust fan

(H)

Wall switch

8

240 volt power outlet

Φ

LED Downlight

Ø

Ceiling mounted smoke detector hard wired with battery back up

Electrical Legend

1:100

1st Floor Electrical Layout



CONTRACTOR NOTE:

BUILDING CONTRACTORS

BUILDING CONTRACTORS

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Surfmist or similar

Rainwater tank

1F CL 5800

₹

2400

2700

7600


RHP

2

1800

Front Elevation

1:100

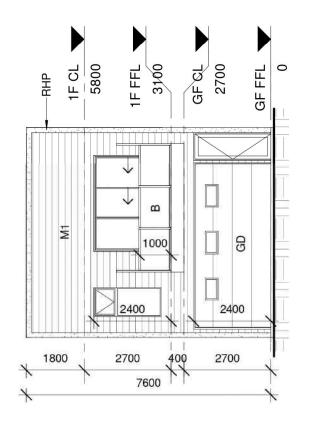

COLOUR SCHEDULE

Gliderol Hampton Surfmist Rev Roofing Surfmist Rev Roofing Surfmist Dulux Natural White Dowel Satin Black Dowel Satin Black Dowel Satin Black PGH Tribeca Red Dulux Monument Traditional Single **Dulux Monument Dulux Surfmist** Dulux Surfmist **Brighton Light** Satin Black Surfmist Surfmist Sectional Garage Door Windows Aluminium Fly Screen & Doors Framed Glass Balustrade Aluminium Sliding Doors Sectional Garage Door Front Fence (1.2m H) Aluminium Windows Face Brick Cladding Front Door Frame Grout Flush Joint Render Finish Metal Fascia Eave Lining Front Door Downpipes Meter Box Roofing Gutters

EXTERNAL FINISH SCHEDULE

3100 1F FFL

ద

GFCL 2700

₹

2400

2700

Rendered 50mm Hebel Power Panel Cladding RHP

Scyon Stria Cladding Ξ

2.4m x 5.1m Panel Lift Door GD

GF FFL

Downpipe DP

50mm Hebel Power Panel Cladding 모

Rear Elevation

1:100

NEW CREATION GROUP BUILDING CONTRACTORS CONTRACTOR NOTE:

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COUNTRACTOR ARE TO WEHFY ALL DIMBISIONS ON SITE BEFORE COMMENCING ANY WORK FEGURED DIMBISIONS SHALL TAKE PRECEREDECE VERS CALED DIMBISIONS AND ANY DISCREPANCES ALL BE REPORTED TO THE DESIGNER MANEDATELY

Scale As indicated Sheet No. A106

Palmyra Housing Development

5-9 Palmyra Ave, Torrensville

Mrs Tania Russell


Revision Date 17.08.21

NewCreation







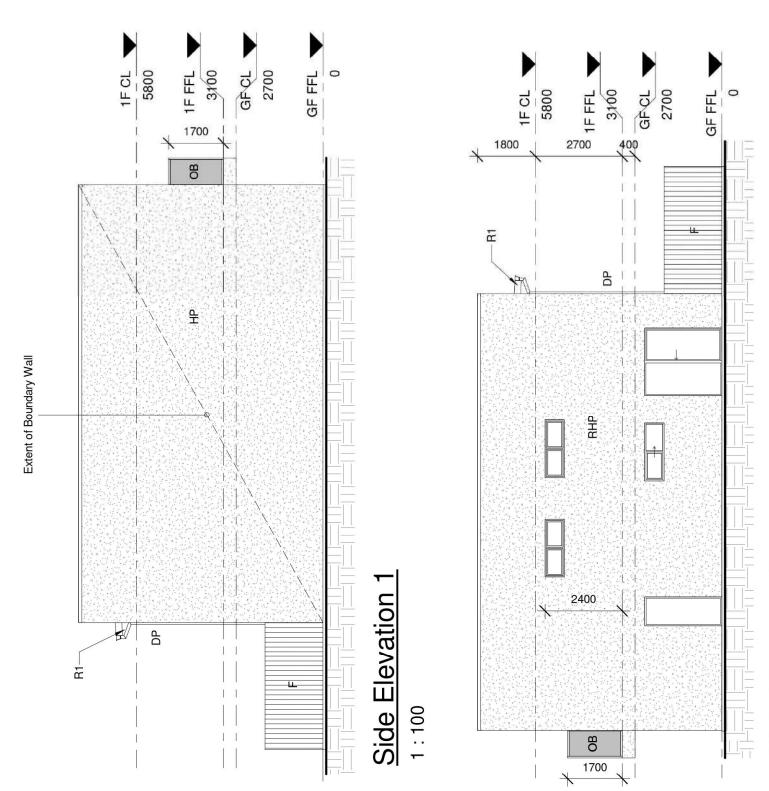

α Side Elevation

1:100

ၓ	COLOUR SCHEDULE		COLOUR SCHEDULE		EXTER	EXTERNAL FINISH SCHEDULE
Alc	Aluminium Windows	Dowel Satin Black	Front Door Frame	Dulux Monument	RHP	Rendered 50mm Hebel Power Panel
Alt	Aluminium Sliding Doors	Dowel Satin Black	Face Brick Cladding	PGH Tribeca Red	0	
Alc	Aluminium Fly Screen & Doors	Dowel Satin Black	Grout Flush Joint	Brighton Light	5 2	Obscured Glazing
Еа	Eave Lining	Dulux Natural White	Sectional Garage Door	Gliderol Hampton Surfmist	<u> </u>	Town D. Cood Niciathers Colonbord Learned
ย	Gutters	Rev Roofing Surfmist	Sectional Garage Door Windows	Traditional Single	ш	parti fence, Colour: Woodland Grey or similar
Me	Metal Fascia	Rev Roofing Surfmist	Roofing	Surfmist	랖	50mm Hebel Power Panel Cladding
õ	Downpipes	Dulux Surfmist	Meter Box	Surfmist		
Re	Render Finish	Dulux Surfmist	Framed Glass Balustrade	Satin Black		
Я	Front Door	Dulux Monument	Front Fence (1.2m H)	Powder coated satin black		
			Rainwater tank	Surfmist or similar		


Palmyra Housing Development 5-9 Palmyra Ave, Torrensville Mrs Tania Russell


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Section 2

1:50

5-9 Palmyra Ave, Torrensville Palmyra Housing Development Revision Date 17.08.21 Scale 1:50 Sheet No.

A109

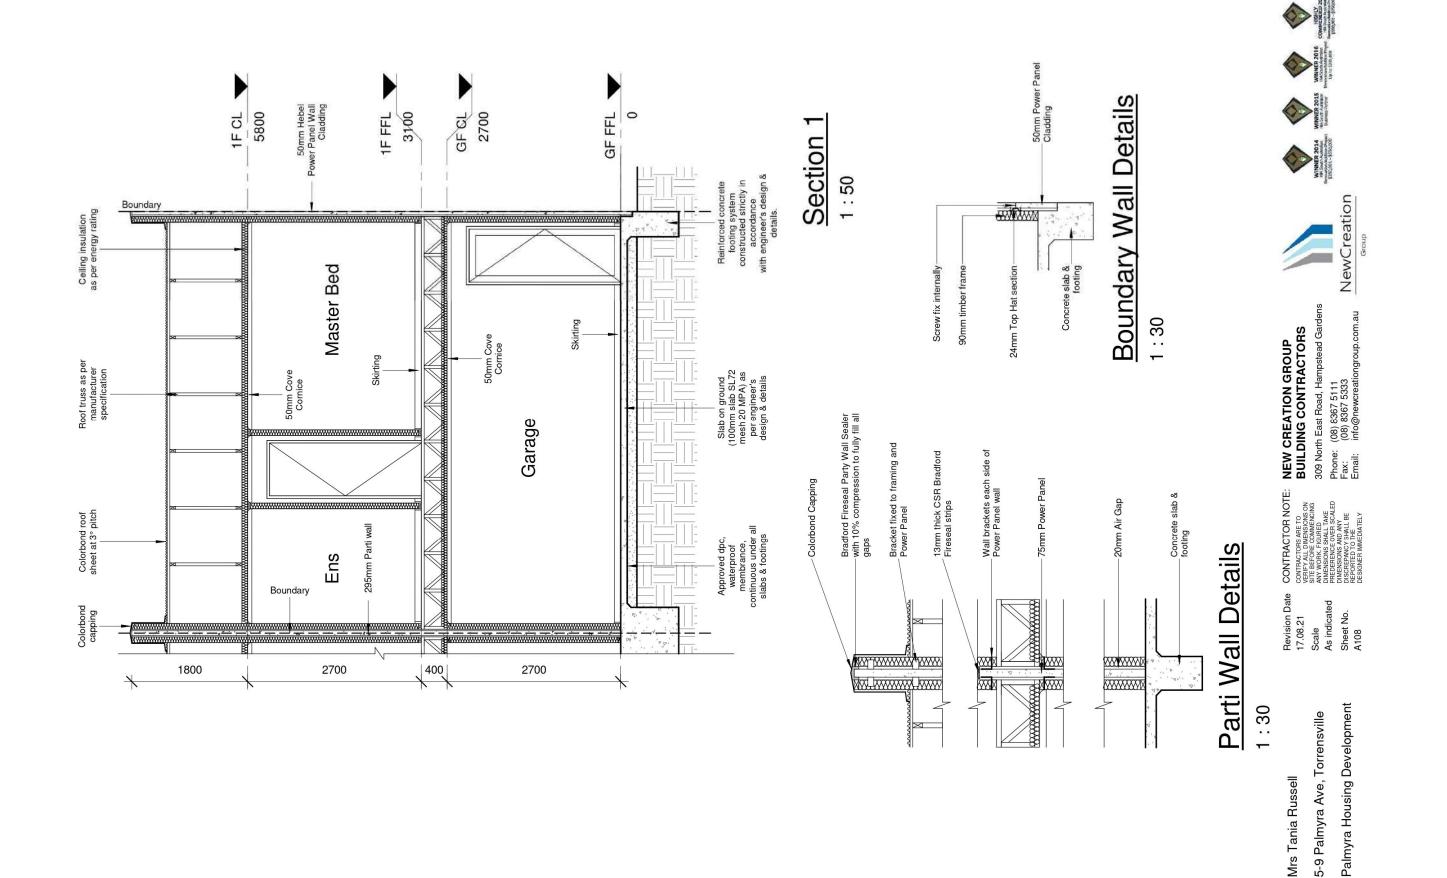CONTRACTOR NOT CONTRACTORS ARE TO VERIFY ALL DIMENSIONS ON SITE BEFORE COMMENCING ANY WORK. FIGURED DIMENSIONS SHALL TAKE PREDERIENCE OVER SCALED DIMENSIONS AND ANY DISCREPANCY SHALL BE REPORTED TO THE DESIGNER IMMEDIATELY

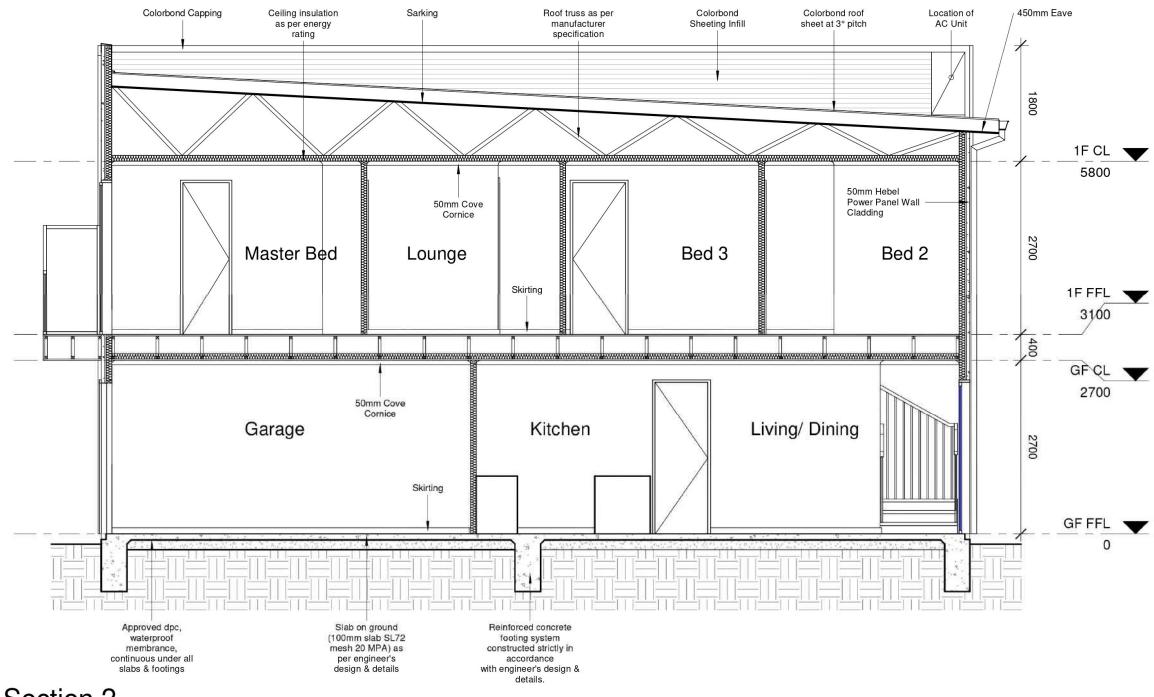CONTRACTOR NOTE:

NEW CREATION GROUP BUILDING CONTRACTORS

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Phone: (08) 8367 5111 Fax: (08) 8367 5333

Fax: (08) 8367 5333 Email: info@newcreationgroup.com.au












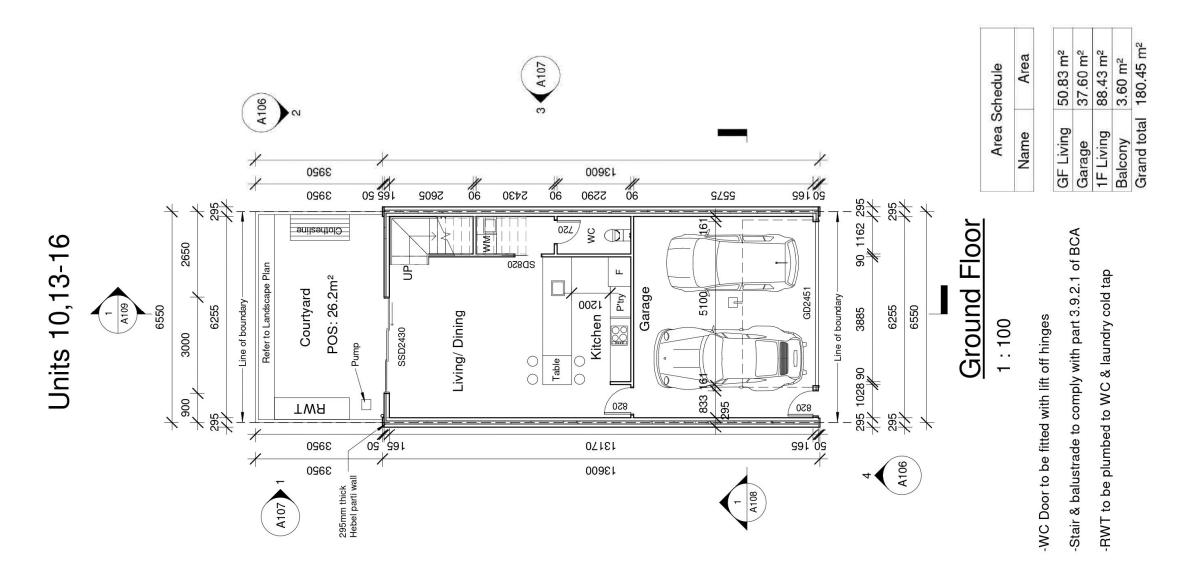

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BUILDING CONTRACTORS
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CONTRACTOR NOTE:


Revision Date 17.08.21

Mrs Tania Russell

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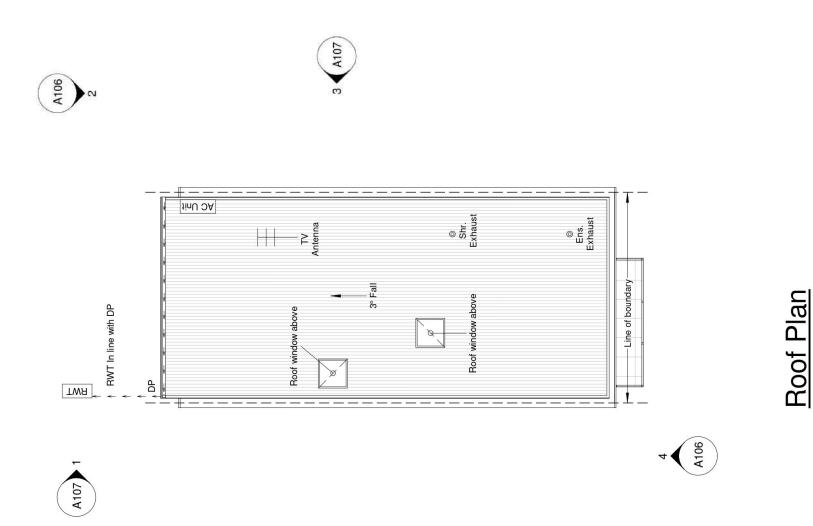
> Scale 1:100 Sheet No. A101

5-9 Palmyra Ave, Torrensville Palmyra Housing Development

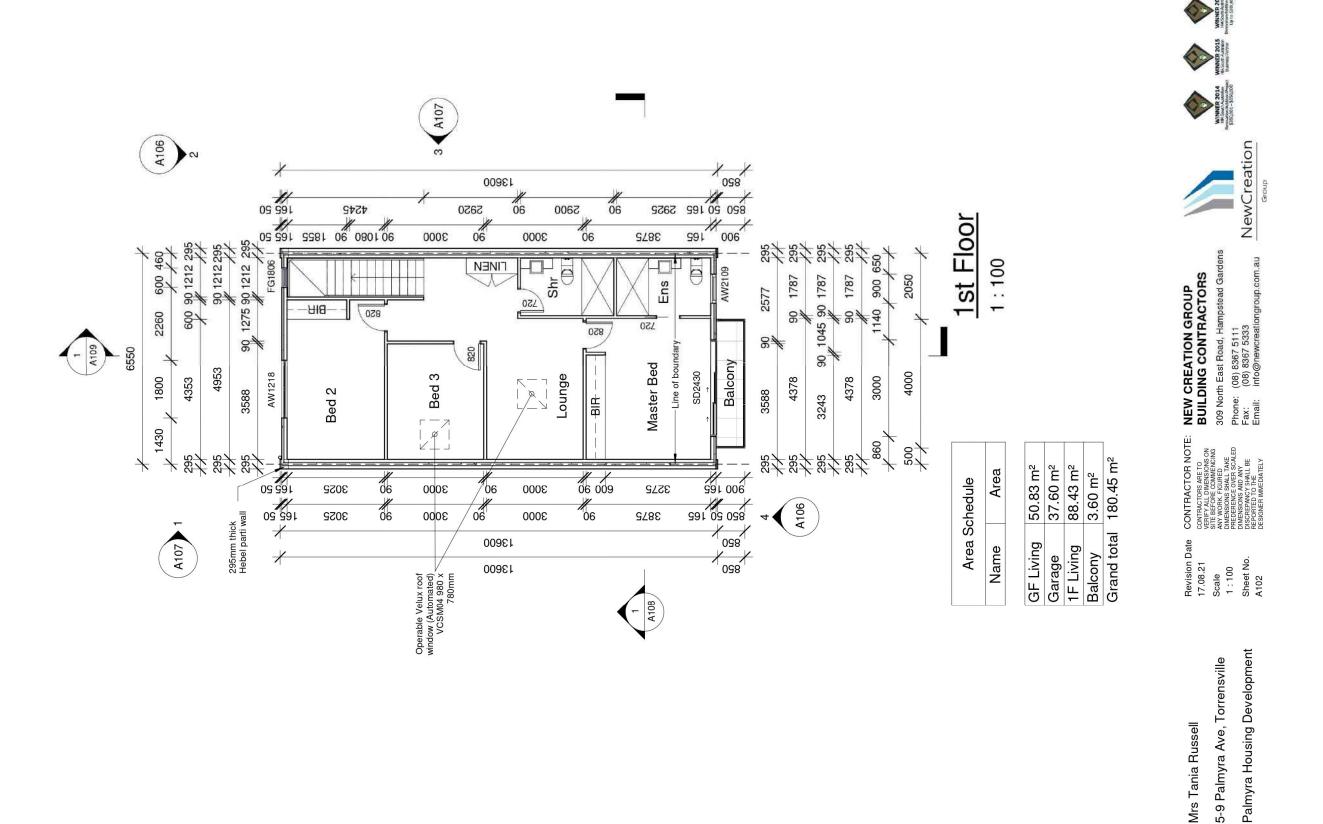

9 November 2021 Page 44

Mrs Tania Russell




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Revision Date 17.08.21 Scale 1:100 Sheet No. A103

Palmyra Housing Development 5-9 Palmyra Ave, Torrensville

Mrs Tania Russell



Electrical Legend

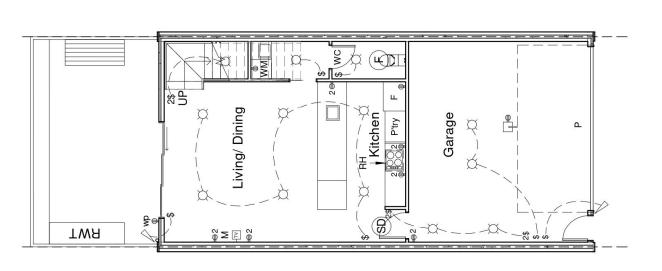- Ceiling mounted smoke detector hard wired with battery back up (SD)
- LED downlight
- 240 volt power outlet
- 240 volt double power outlet
- Wall switch ↔
- 2 Way wall switch (L) 2\$
 - Exhaust Modem Σ
- TV Point
- 240 volt double weather proof power outlet dw ⊕ 2
- Sensor light
- Rangehood
- Automated Panel Lift Door

Ground Floor Electrical Layout

1:100

CONTRACTOR NOTE:

Revision Date 17.08.21 Scale 1:100 Sheet No. A104

Palmyra Housing Development 5-9 Palmyra Ave, Torrensville

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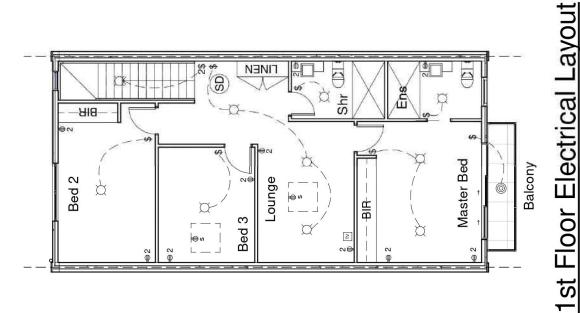












Electrical Legend

- Ceiling mounted smoke detector hard wired with battery back up
- LED Downlight

Ø

- 240 volt power outlet
- 240 volt double power outlet

2⊕

- Wall switch 8
- Power to skylights
- External LED Downlight 0

1:100

CONTRACTOR NOTE: CONTRACTORS ARE TO VERIFY ALL DIMENSIONS ON SITE BEFORE COMMENSIONS SITE BEFORE COMMENSIONS ON DIMENSIONS SHALL TARE PREDERENCE OVER SCALED DIMENSIONS SHALL BE EMPORTED TO THE BEFORED TO THE BEFORED TO THE DESIGNER MIMEDIA FILE

Revision Date 17.08.21 Scale 1:100 Sheet No. A105

Palmyra Housing Development 5-9 Palmyra Ave, Torrensville

Mrs Tania Russell


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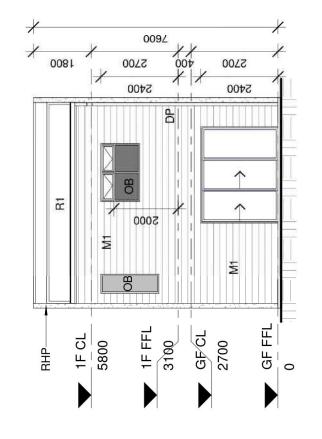






Front Elevation

1:100

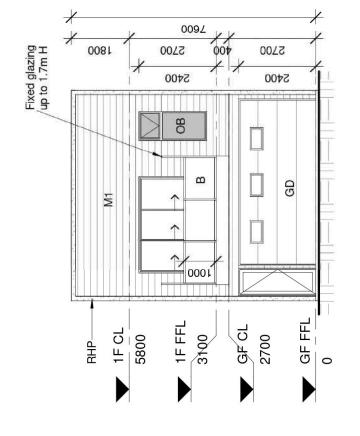

Rear Elevation

1:100



Powder coated satin black Gliderol Hampton Surfmist Rev Roofing Surfmist Rev Roofing Surfmist Dulux Natural White Dowel Satin Black Dowel Satin Black Dowel Satin Black PGH Tribeca Red Surfmist or similar Traditional Single Dulux Monument Dulux Monument **Dulux Surfmist Dulux Surfmist Brighton Light** Satin Black Surfmist Surfmist Aluminium Fly Screen & Doors Sectional Garage Door Window Framed Glass Balustrade Aluminium Sliding Doors Sectional Garage Door Front Fence (1.2m H) Aluminium Windows Face Brick Cladding Front Door Frame Grout Flush Joint Render Finish Metal Fascia Eave Lining Downpipes Front Door Meter Box Roofing Gutters

EXTERNAL FINISH SCHEDULE

Rainwater tank

Rendered 50mm Hebel Power Panel Cladding RHP

Scyon Stria Cladding \mathbf{M}

2.4m x 5.1m Panel Lift Door Colorbond Roof @ 3° Pitch GD **E**

Obscure Glazing OB

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Scale As indicated Sheet No. A106


Palmyra Housing Development


5-9 Palmyra Ave, Torrensville

Mrs Tania Russell

CONTRACTOR NOTE:

Revision Date 17,08.21

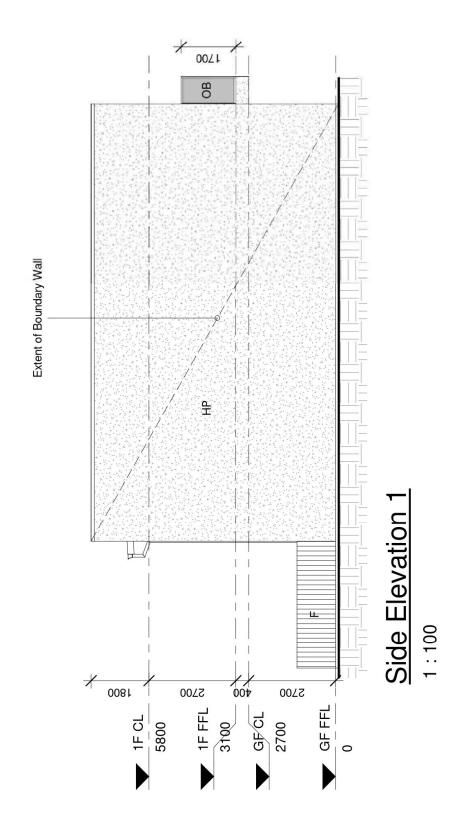

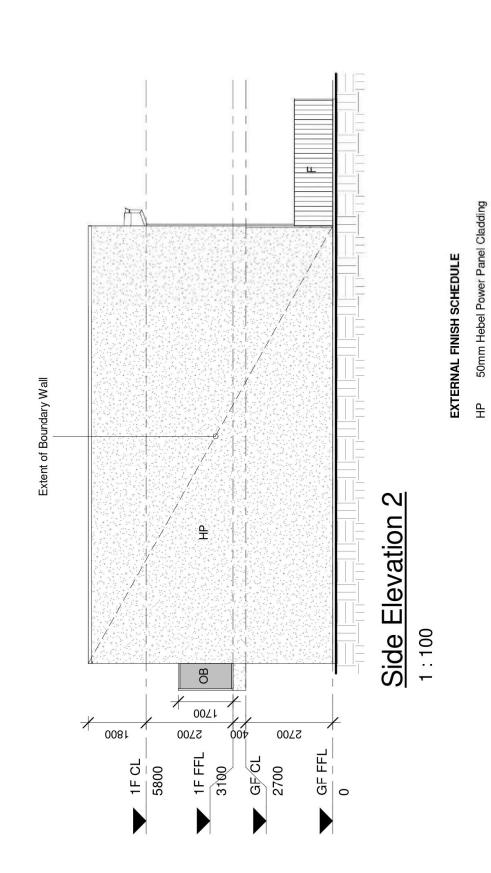

Palmyra Housing Development 5-9 Palmyra Ave, Torrensville Mrs Tania Russell


CONTRACTOR NOTE: Revision Date 17.08.21 Scale As indicated Sheet No. A107

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1.8m H Good Neighbour Colorbond Internal parti fence. Colour: Woodland Grey or similar

Obscured Glazing

OB

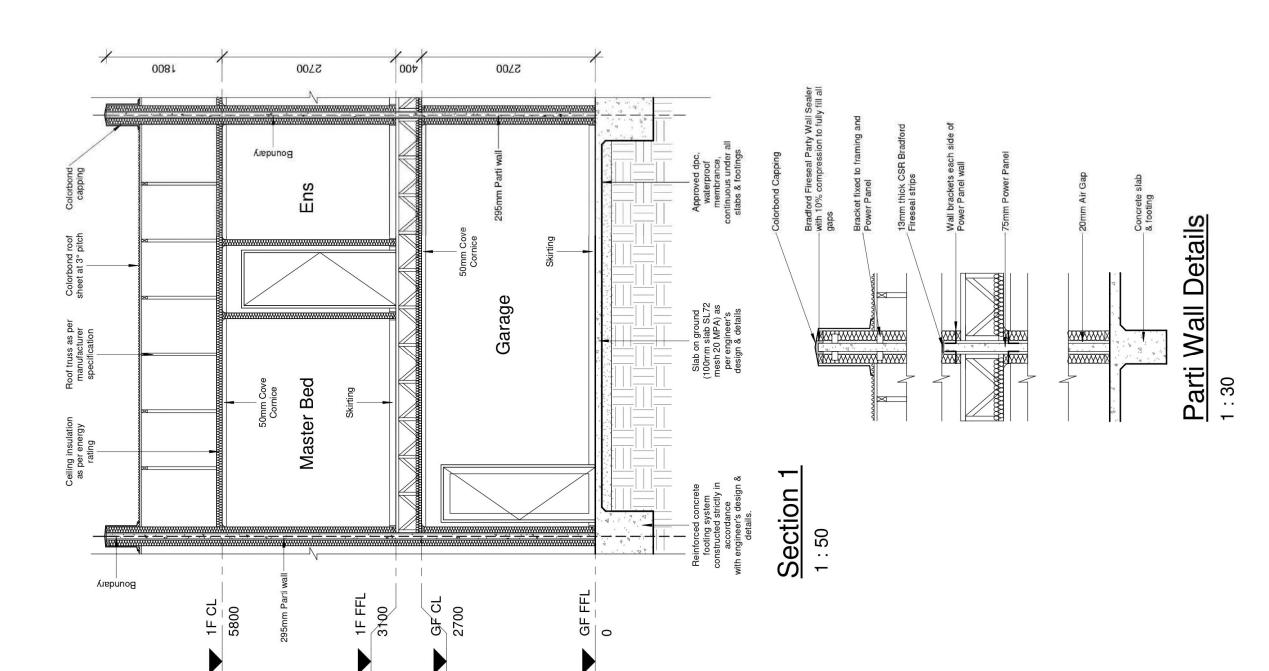

Palmyra Housing Development 5-9 Palmyra Ave, Torrensville Mrs Tania Russell


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5-9 Palmyra Ave, Torrensville Palmyra Housing Development Revision Date 17.08.21 Scale 1:50

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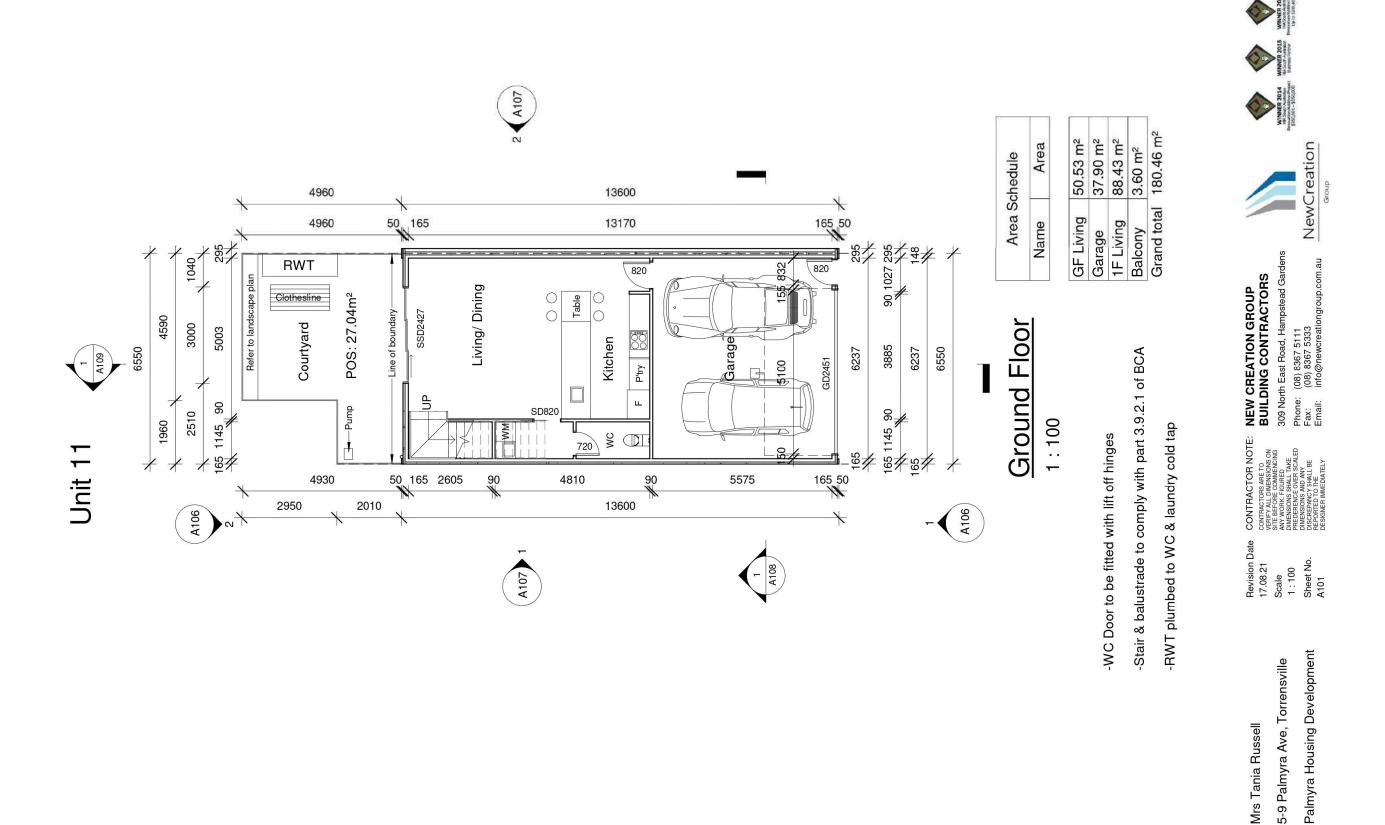







9 November 2021 Page 51

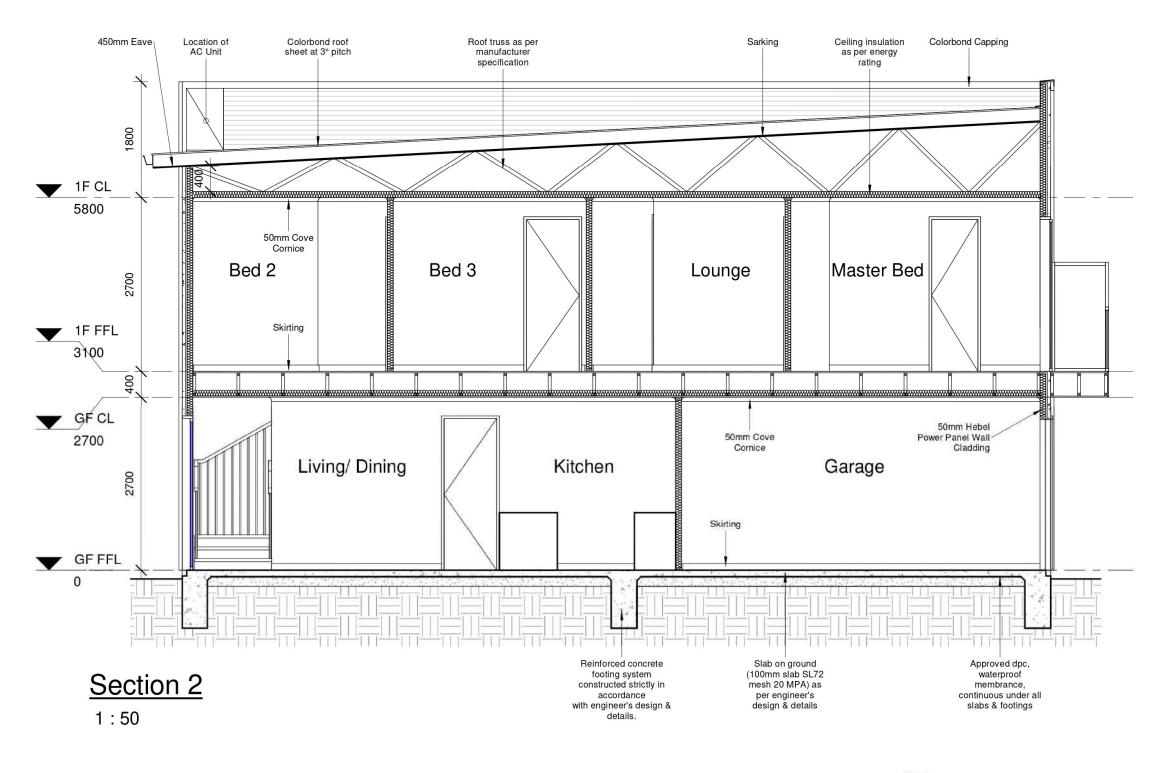
CONTRACTOR NOTE:



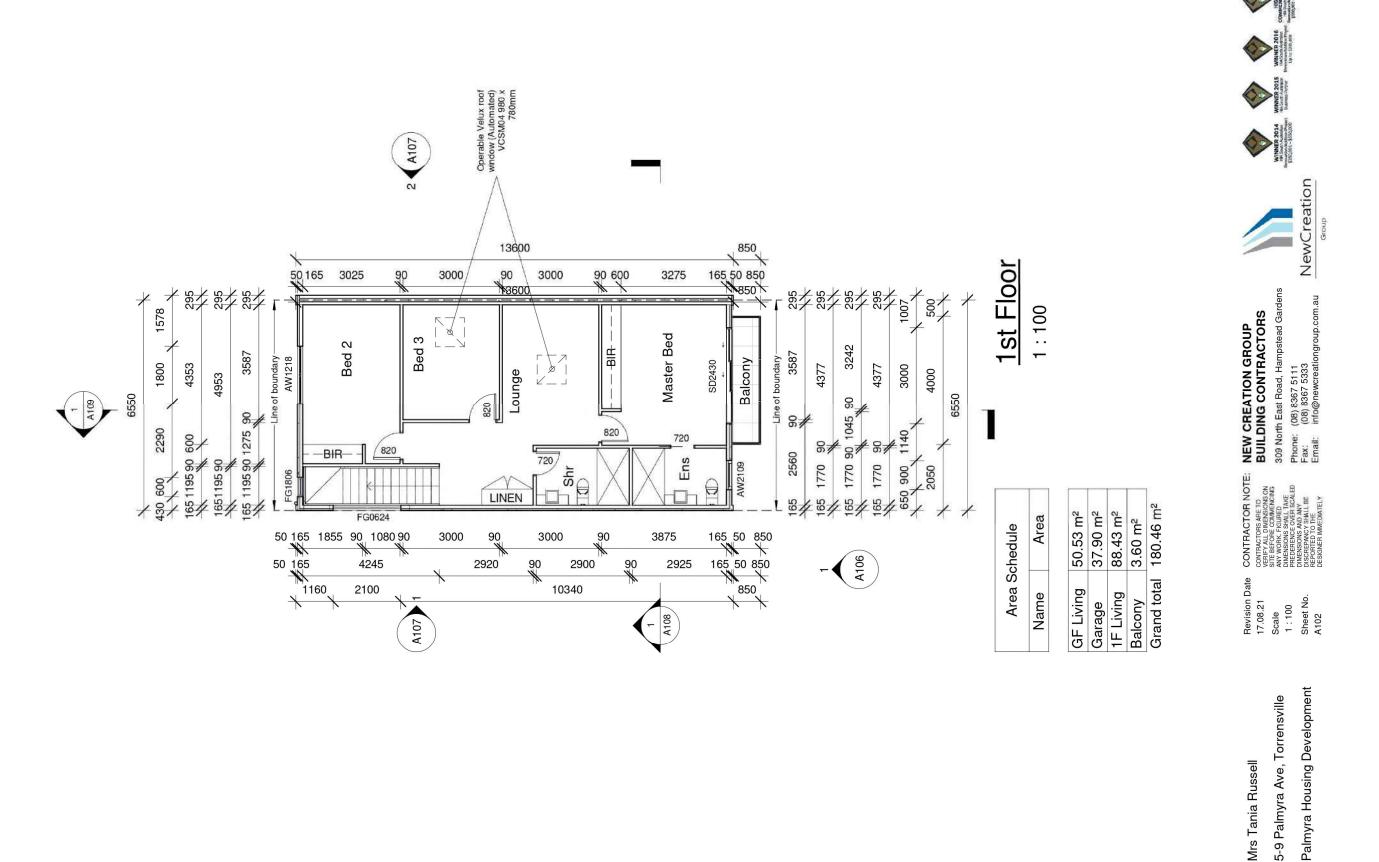

9 November 2021 Page 53

Mrs Tania Russell

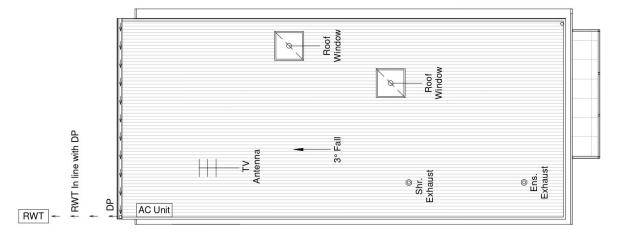

Roof Plan 1:100


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Palmyra Housing Development 5-9 Palmyra Ave, Torrensville Mrs Tania Russell

Revision Date 17.08.21 Scale 1:100 Sheet No. A103

CONTRACTOR NOTE:

Page 54

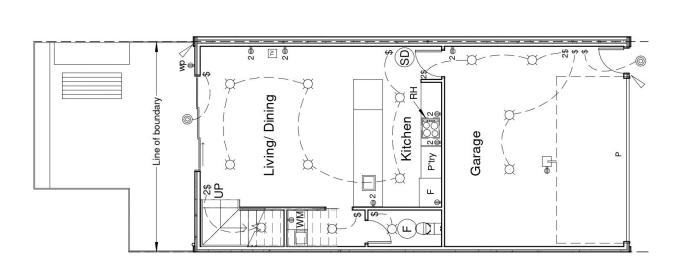

- Ceiling mounted smoke detector hard wired with battery back up
- LED downlight fitting
- 240 volt power outlet
- 240 volt double power outlet
- Wall switch Exhaust $\qquad \qquad \square$

8

- TV Point 2
- 240 volt double weather proof power outlet dw ⊕
- Sensor light 4
- External LED downlight fitting

0

Ground Floor Electrical Layout

1:100

Palmyra Housing Development Mrs Tania Russell

5-9 Palmyra Ave, Torrensville

Revision Date 17.08.21 Scale 1:100 Sheet No. A104

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External LED downlight fitting


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Exhaust fan

<u>ш</u>

Wall switch

↔

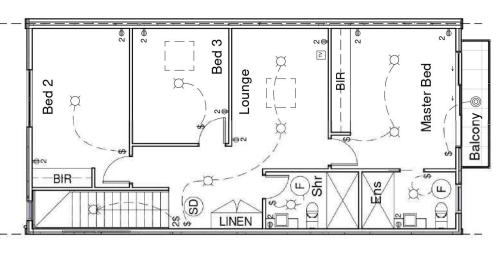

240 volt double power outlet

2⊕

240 volt power outlet

LED downlight fitting

Ceiling mounted smoke detector hard wired with battery back up

Electrical Legend

1st Floor Electrical Layout 1:100 CONTRACTOR NOTE: CONTRACTORS ARE TO VERHY ALL DIBENSIONS ON SHE BEFORE COMMENCING ANY WORK FEDURED DIMENSIONS SHALL TAKE PREDIETRICE OVER SCALED DIMENSIONS AND ANY DISCREPANCY SHALL BE REPORTED TO THE PERFORMED TO THE DESIGNER MAKEDATELY

Revision Date 17.08.21 Scale 1:100 Sheet No. A105

Palmyra Housing Development 5-9 Palmyra Ave, Torrensville

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Surfmist or similar

Rainwater tank

5800

1F CL


RHP

8

1800

Front Elevation

1:100

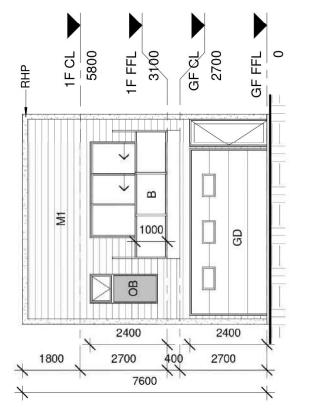

COLOUR SCHEDULE

Powder coated satin black Gliderol Hampton Surfmist Rev Roofing Surfmist Rev Roofing Surfmist Dulux Natural White Dowel Satin Black Dowel Satin Black Dowel Satin Black PGH Tribeca Red **Traditional Single** Dulux Monument Dulux Monument Dulux Surfmist **Dulux Surfmist Brighton Light** Satin Black Surfmist Surfmist Sectional Garage Door Windows Aluminium Fly Screen & Doors Framed Glass Balustrade Aluminium Sliding Doors Sectional Garage Door Front Fence (1.2m H) Aluminium Windows Face Brick Cladding Front Door Frame Grout Flush Joint Render Finish Metal Fascia Eave Lining Downpipes Meter Box Front Door Gutters Roofing

EXTERNAL FINISH SCHEDULE

3100

GFCL 2700

DP

ž

2400

2700

1F FFL

2400

2000

7600

2700

400

₹

Rendered 50mm Hebel Power Panel Cladding RHP

Scyon Stria Cladding

2.4m x 5.1m Panel Lift Door В

Obscure glazing OB

GF FFL

0

Rear Elevation

1:100



Revision Date 17,08.21

Scale As indicated Sheet No. A106

Palmyra Housing Development

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Page 57

> 1F CL 5800

1800

H

Extent of Boundary Wall

1F FFL

2700

3100

DP

呈


OB 1700 GFCL

400

2700

2700

GF FFL

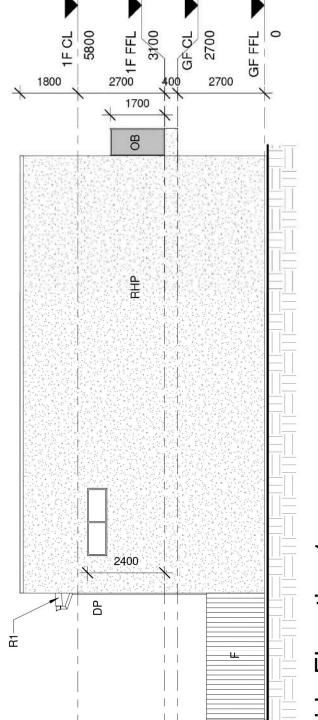

Side Elevation

1:100

2 Side Elevation

1:100

EXTERNAL FINISH SCHEDULE

- Rendered 50mm Hebel Power Panel Cladding RHP
- Obscured Glazing OB
- 1.8m H Good Neighbour Colorbond Internal parti fence. Colour: Woodland Grey or similar ட
- Η

50mm Hebel Power Panel Cladding

Palmyra Housing Development 5-9 Palmyra Ave, Torrensville Mrs Tania Russell

CONTRACTOR NOTE: Revision Date 17.08.21 Scale As indicated Sheet No. A107

BUILDING CONTRACTORS

BUILDING CONTRACTORS


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9 November 2021

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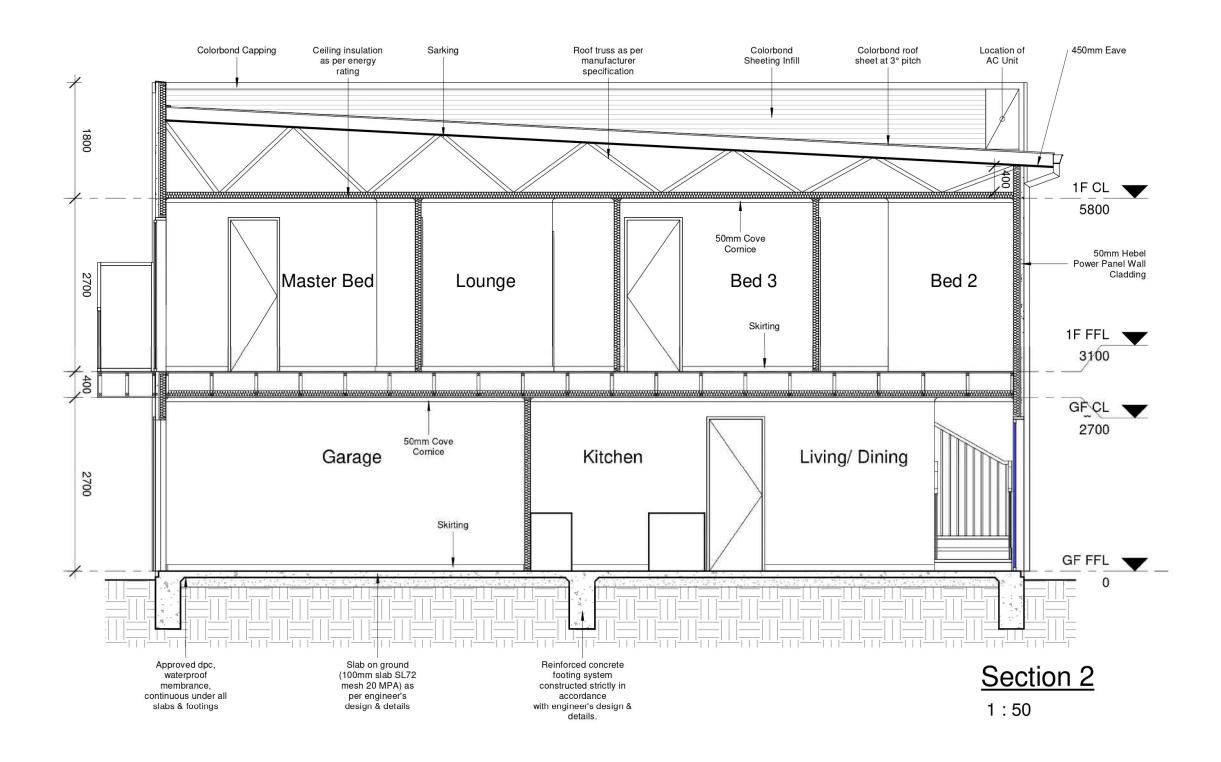
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Palmyra Housing Development 5-9 Palmyra Ave, Torrensville

Page 59



Mrs Tania Russell

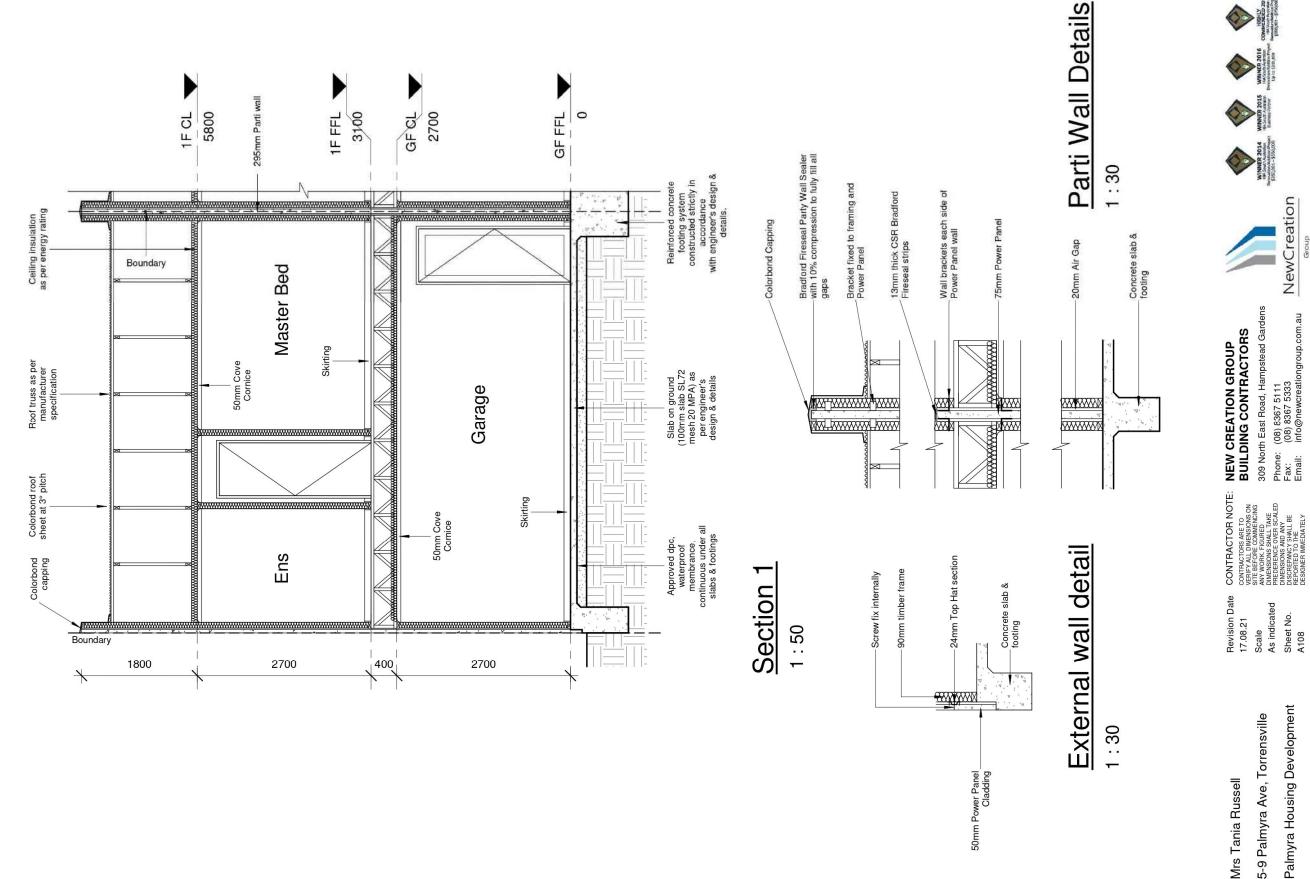5-9 Palmyra Ave, Torrensville

Palmyra Housing Development

17.08.21 Scale

1:50 Sheet No. A109

CONTRACTOR NOTE
CONTRACTORS ARE TO
VERIEY ALL DIMENSIONS ON
SITE BEFORE COMMENCING
ANY WORK FIGURED
DIMENSIONS SHALL TAKE
PREDERENGE OVER SCALED
DIMENSIONS AND ANY
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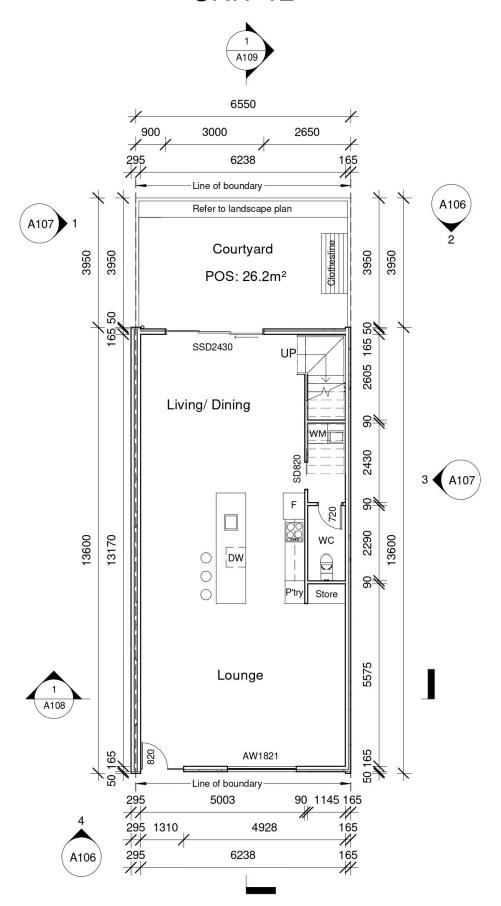








UNIT 12



Ground Floor

1:100

Area Schedule Name Area

-WC Door to be fitted with lift off hinges

-Stair & balustrade to comply with part 3.9.2.1 of BCA

-RWT plumbed to WC & laundry cold tap

GF Living	88.42 m ²
1F Living	88.43 m ²
Grand total	176 85 m ²

Mrs Tania Russell 5-9 Palmyra Ave, Torrensville Palmyra Housing Development

17.08.21 Scale 1:100 Sheet No.

A101

CONTRACTOR NOT VERRY ALL DIMENSIONS ON SITE BEFORE COMMENCING ANY WORK, FIGURED DIMENSIONS SHALL TAKE PREDERENCE OVER SCALED DIMENSIONS AND ANY DISCREPANCY SHALL BE REPORTED TO THE DESIGNER IMMEDIATELY

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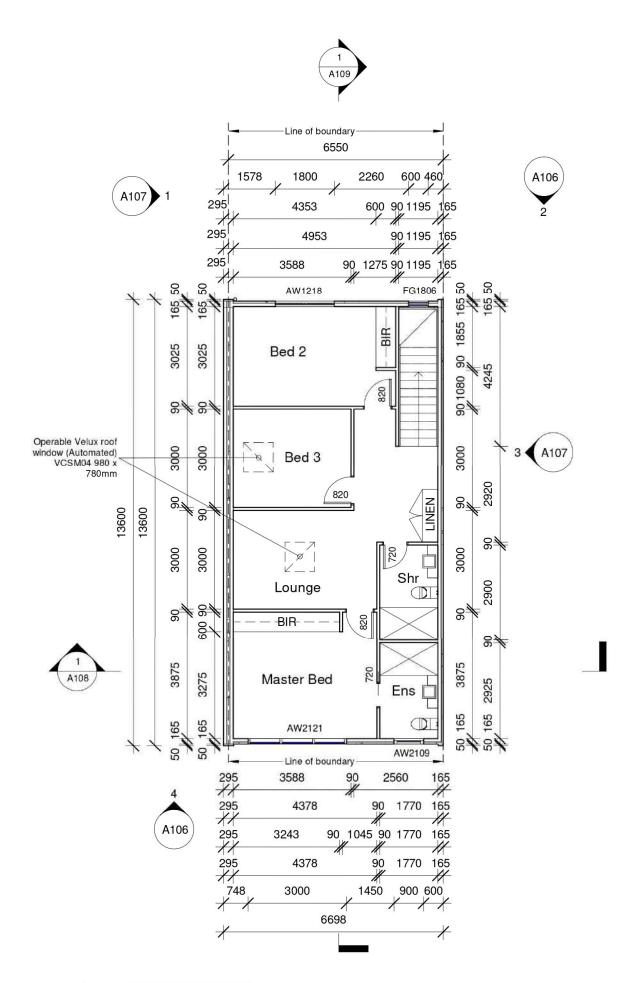












Area Schedule Name Area

GF Living 88.42 m² 1F Living 88.43 m² 1st Floor 1:100

Grand total 176.85 m²

Mrs Tania Russell 5-9 Palmyra Ave, Torrensville Palmyra Housing Development 17.08.21 Scale 1:100

Sheet No.

A102

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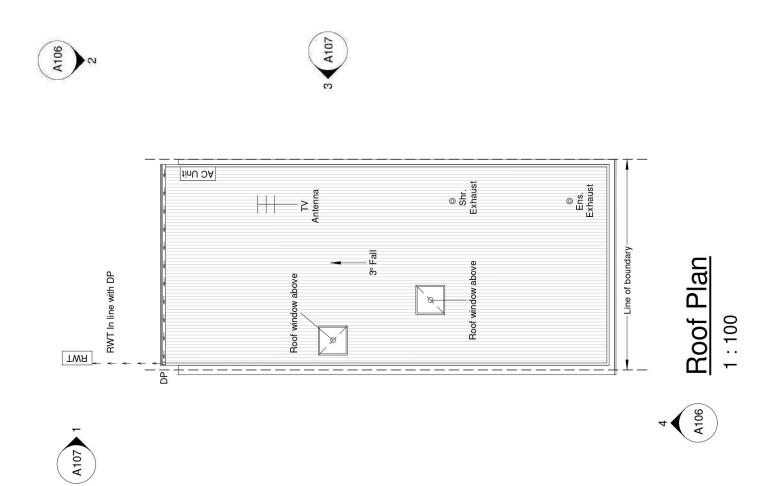














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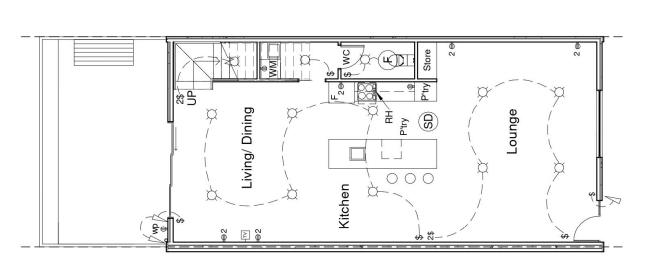
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Revision Date 17.08.21 Scale 1:100 Sheet No. A103

Palmyra Housing Development

5-9 Palmyra Ave, Torrensville

Mrs Tania Russell



Electrical Legend

Ceiling mounted smoke detector hard wired with battery back up (SD)

240 volt power outlet LED downlight

240 volt double power outlet

Wall switch

↔

Exhaust (H)

2 Way wall switch

2\$

External Downlight 0

TV Point 2 240 volt double weather proof power outlet dw ⊕

Sensor light

Flourescent Light

Rangehood

표

Ground Floor Electrical Layout

1:100

Palmyra Housing Development 5-9 Palmyra Ave, Torrensville Mrs Tania Russell

CONTRACTOR NOTE: Revision Date 17.08.21 Scale 1:100 Sheet No. A104

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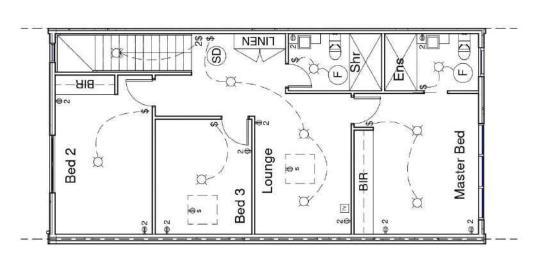












Electrical Legend

- Ceiling mounted smoke detector hard wired with battery back up
 - LED Downlight

Ø

240 volt power outlet

Φ

- 240 volt double power outlet
 - Wall switch ↔
 - Exhaust (L)
- es Power to skylights

1st Floor Electrical Layout

1:100



CONTRACTOR NOTE:

Revision Date 17.08.21 Scale 1:100 Sheet No. A105

Palmyra Housing Development

5-9 Palmyra Ave, Torrensville

Mrs Tania Russell

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Powder coated satin black

Satin Black

Framed Glass Balustrade

Meter Box

Front Fence (1.2m H)

Rainwater tank

Surfmist

Surfmist or similar

Rendered 50mm Hebel Power Panel Cladding


RHP Ξ

EXTERNAL FINISH SCHEDULE

Colorbond Roof @ 5° Pitch

Obscure Glazing

Scyon Stria Cladding

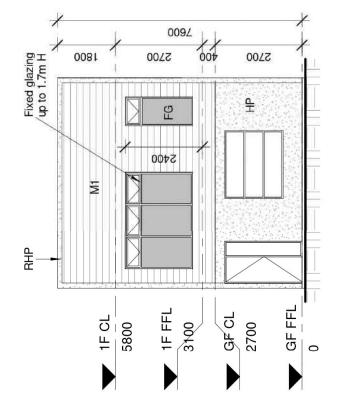

Rev Roofing Surfmist Rev Roofing Surfmist **Dulux Natural White**

Metal Fascia

Dulux Surfmist Dulux Surfmist

Dowel Satin Black Dowel Satin Black

Aluminium Fly Screen & Doors

Eave Lining

Gutters

Aluminium Sliding Doors

Aluminium Windows

COLOUR SCHEDULE

Dowel Satin Black

Front Elevation

1:100

Gliderol Hampton Surfmist

Traditional Single

Sectional Garage Door Windows

Sectional Garage Door

Surfmist

PGH Tribeca Red

Face Brick Cladding

Grout Flush Joint

Front Door Frame


Render Finish

Front Door

Downpipes

Brighton Light

Dulux Monument Dulux Monument

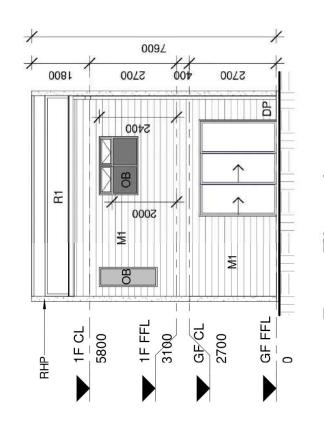

Rear Elevation

1:100



CONTRACTOR NOTE:

Revision Date 17,08.21

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Palmyra Housing Development

5-9 Palmyra Ave, Torrensville

Mrs Tania Russell


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Page 66



1.8m H Good Neighbour Colorbond Internal parti fence. Colour: Woodland Grey or similar

Obscured Glazing

OB

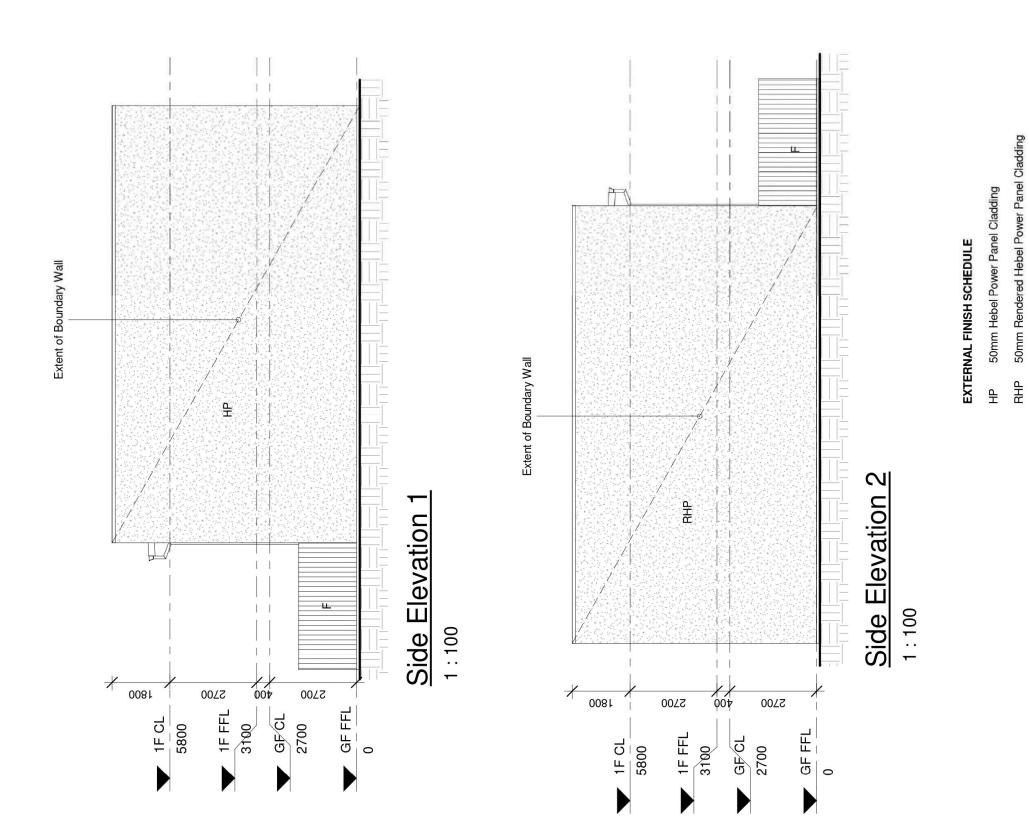
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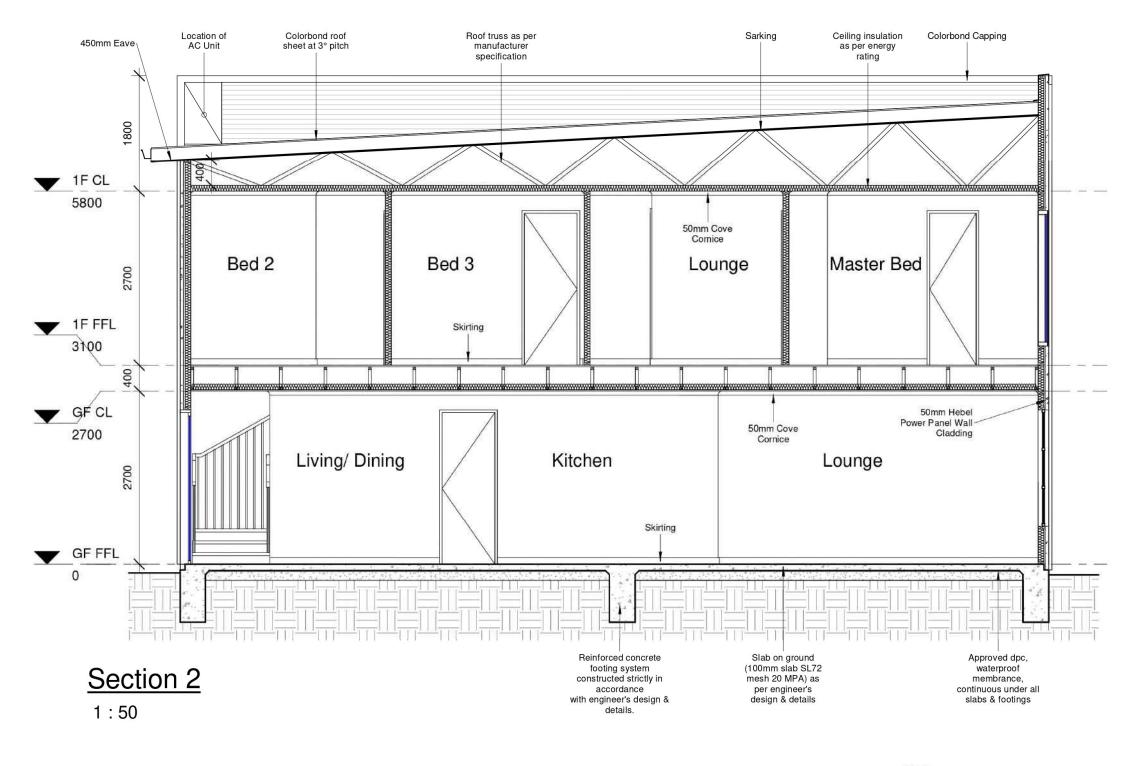
CONTRACTOR NOTE:

Palmyra Housing Development

5-9 Palmyra Ave, Torrensville

Mrs Tania Russell



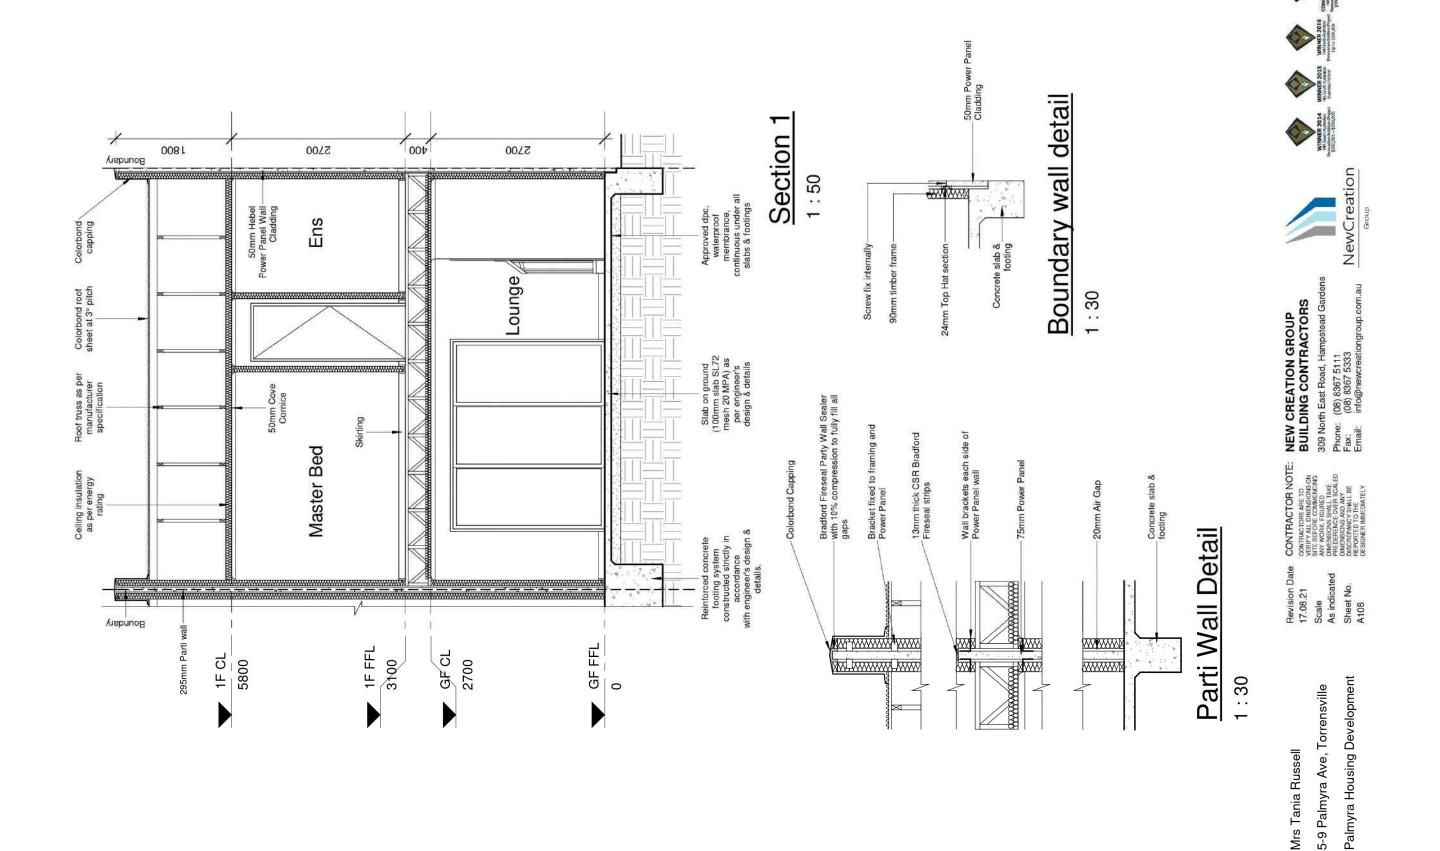

5-9 Palmyra Ave, Torrensville Palmyra Housing Development Revision Date 17.08.21 Scale 1:50 Sheet No.

A109

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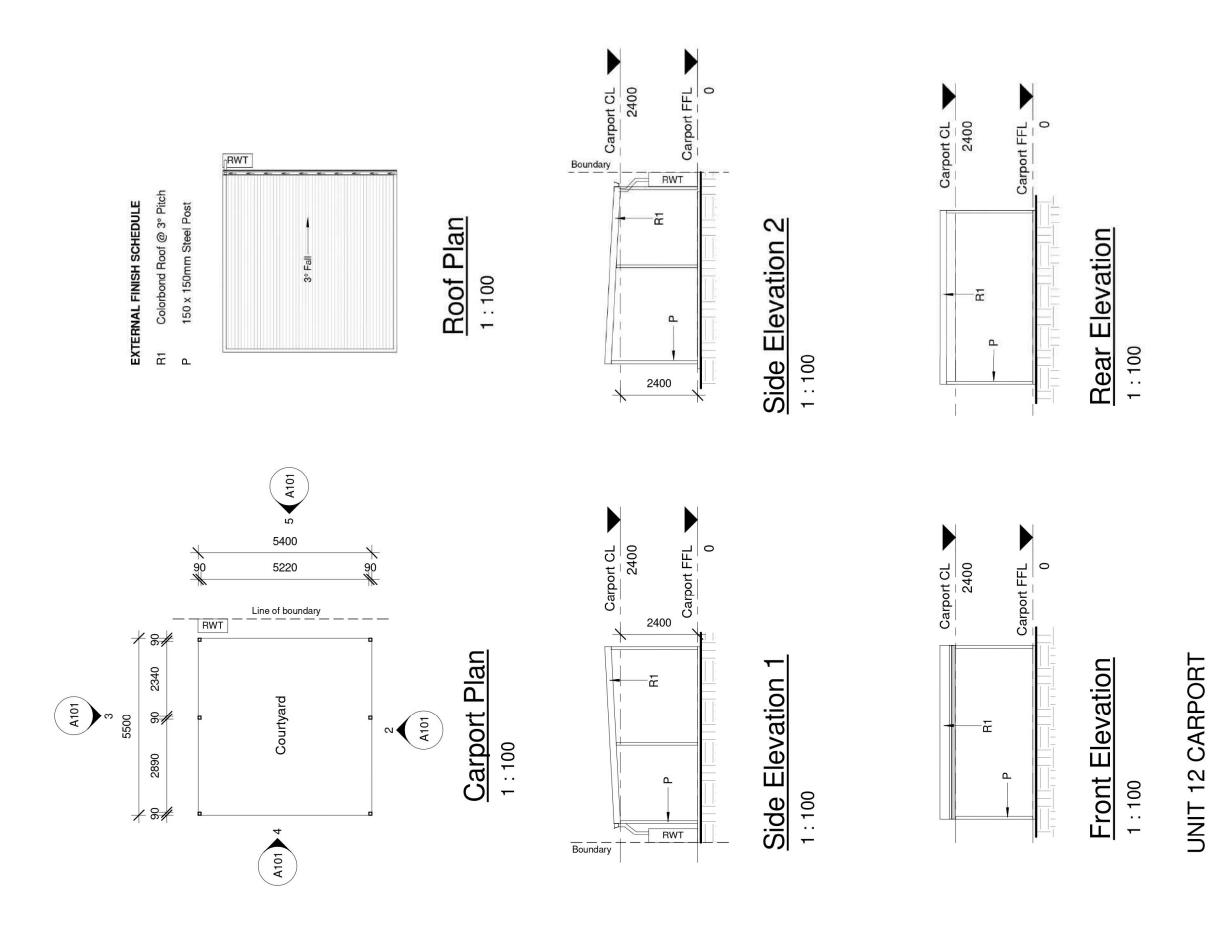
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Revision Date 02.08.21 Scale As indicated Sheet No.

> 5-9 Palmyra Ave, Torrensville Palmyra Housing Development

Mrs Tania Russell



149.84 m² 74.92 m² 74.92 m² Area Schedule GF Living 1F Living Grand total Name 17550 25,50,165 165 06 06 06 0007 5002 5430 5290 9299 922 295 ب بی ← بی 90 1162 Ground Floor Clothesline 720 2010 -Stair & balustrade to comply with part 3.9.2.1 of BCA ш 00 SD820 Refer to landscape plan Lounge POS: 26.2m² Courtyard 5237 Line of boundary 3985 3000 910 1:100 -WC Door to be fitted with lift off hinges Dining M 000 165 1305 1000 540 6081WA 6081WA 820 ₹ 1000 1000 165 50 20 165 3950 13170 A106 3960 13600 A107

Revision Date 17.08.21 Scale 1:100 Sheet No. A101 5-9 Palmyra Ave, Torrensville

Mrs Tania Russell


Palmyra Housing Development

CONTRACTOR NOTE:

-RWT to be plumbed to WC & Laundry cold tap

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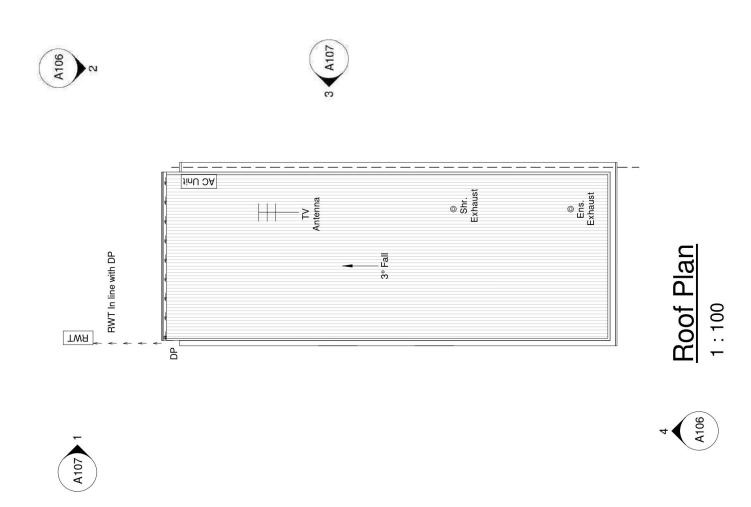
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309 North East Road, Hampstead Garde
Phone: (08) 8367 55111
Fax: (08) 8367 5333
Email: info@newcreationgroup.com.au CONTRACTORS ARE TO VERIEVAL DIMENSIONS ON YEAR BEFORE COMMENSIONS ANY WORK FIGLIRED ANY WORK FIGLIRED PREDIETENCE OVER SCALED DISCREPANCY SHALL BE PREDRIEDORS SHALL BE PREDRIEDO Revision Date 17.08.21 Scale 1:100 Sheet No. A102 Palmyra Housing Development

CONTRACTOR NOTE:

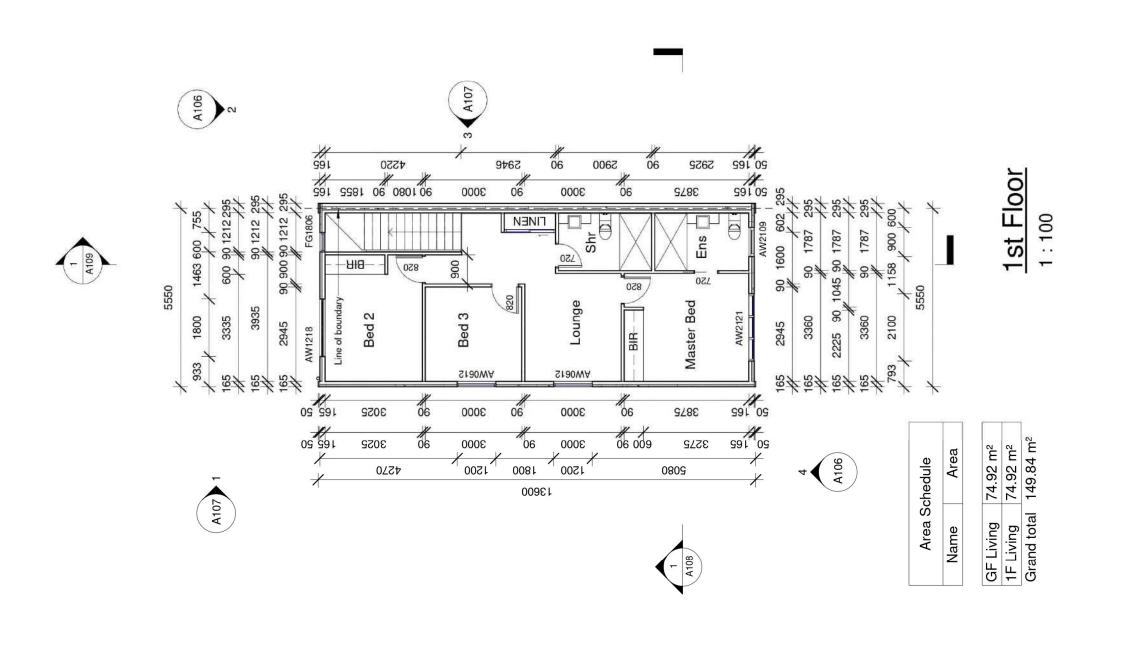5-9 Palmyra Ave, Torrensville

Mrs Tania Russell

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Revision Date 17.08.21 Scale 1:100 Sheet No. A103

Palmyra Housing Development


5-9 Palmyra Ave, Torrensville

Mrs Tania Russell

BUILDING CONTRACTORS

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Phone: (08) 8367 5111
Fax: (08) 8367 5333
Email: info@newcreationgroup.com.au

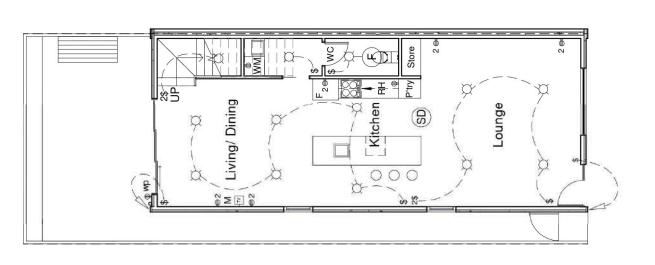

Electrical Legend

Ceiling mounted smoke detector hard wired with battery back up (SD)

LED downlight

240 volt power outlet

240 volt double power outlet 2⊕

Wall switch ↔

2 Way wall switch (L) 2\$

Exhaust

TV Point 2

240 volt double weather proof power outlet dw ⊕

Sensor light

Rangehood

Ground Floor Electrical Layout

1:100

CONTRACTOR NOTE:

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309 North East Road, Hampstead Garde
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Email: info@newcreationgroup.com.au






Revision Date 17.08.21 Scale 1:100 Sheet No. A104

Palmyra Housing Development 5-9 Palmyra Ave, Torrensville

Mrs Tania Russell

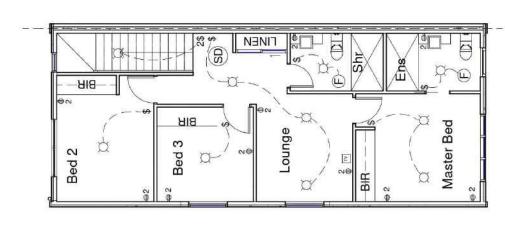

Electrical Legend

- Ceiling mounted smoke detector hard wired with battery back up
 - LED Downlight

Ø

240 volt power outlet

Φ

- 240 volt double power outlet
- Wall switch 2⊕
- Exhaust Fan (H)

1st Floor Electrical Layout

1:100



CONTRACTOR NOTE:

Revision Date 17.08.21 Scale 1:100 Sheet No. A105

Palmyra Housing Development

5-9 Palmyra Ave, Torrensville

Mrs Tania Russell

CONTRACTORS ARE TO VEHEY ALL DIMENSIONS ON SITE BEFORE COMMENDED BANK WORK, FEGURED DIMENSIONS SHALL TARE PREDIENCE OVER SCALED DIMENSIONS AND ANY DISCREPANCY SHALL BE REPORTED TO THE DESIGNER MAKEDIATELY

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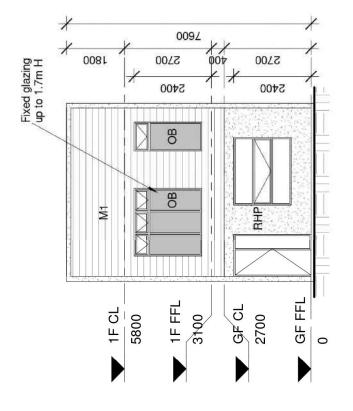









Page 75



Front Elevation

1:100

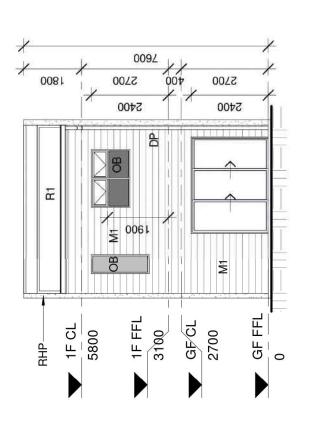

Rear Elevation

1:100

COLOUR SCHEDULE

Gliderol Hampton Surfmist Powder coated satin black Rev Roofing Surfmist Rev Roofing Surfmist Dulux Natural White Dowel Satin Black Dowel Satin Black Dowel Satin Black PGH Tribeca Red Surfmist or simila Traditional Single Dulux Monument Dulux Monument Dulux Surfmist **Dulux Surfmist Brighton Light** Satin Black Surfmist Surfmist Sectional Garage Door Windows Aluminium Fly Screen & Doors Framed Glass Balustrade Aluminium Sliding Doors Sectional Garage Door Front Fence (1.2m H) Aluminium Windows Face Brick Cladding Front Door Frame Grout Flush Joint Render Finish Metal Fascia Eave Lining Downpipes Front Door Meter Box Roofing Gutters

EXTERNAL FINISH SCHEDULE

Rainwater tank

Rendered 50mm Hebel Power Panel Cladding 표

Scyon Stria Gladding

 Ξ 쮼

Colorbond Roof @ 3° Pitch

Obscure Glazing OB

> Palmyra Housing Development 5-9 Palmyra Ave, Torrensville Mrs Tania Russell

CONTRACTOR NOTE:

Revision Date 17,08.21


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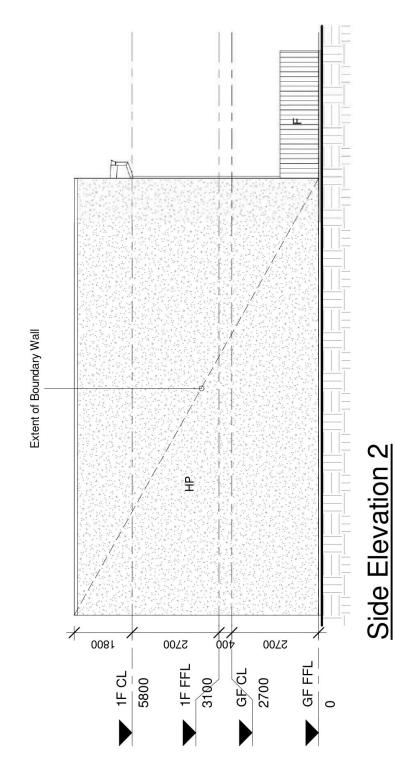
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NEW CREATION GROUP BUILDING CONTRACTORS 309 North East Road, Har







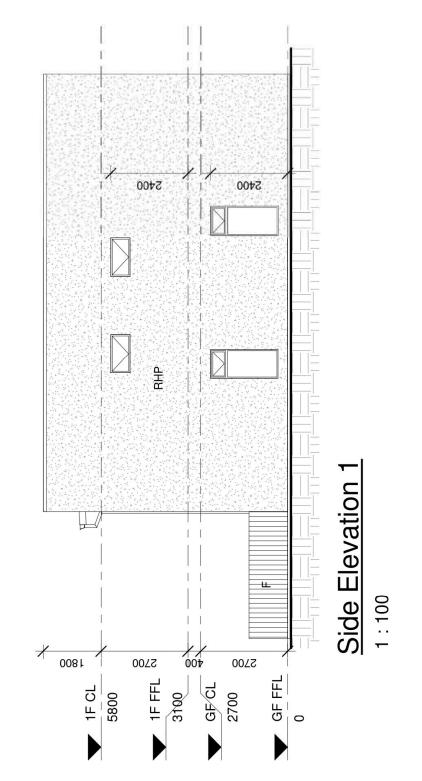

EXTERNAL FINISH SCHEDULE

1:100

Rendered 50mm Hebel Power Panel Cladding RFP 1.8m H Good Neighbour Colorbond Internal parti fence. Colour: Woodland Grey or similar ш

50mm Hebel Power Panel Cladding 모

> Palmyra Housing Development 5-9 Palmyra Ave, Torrensville Mrs Tania Russell

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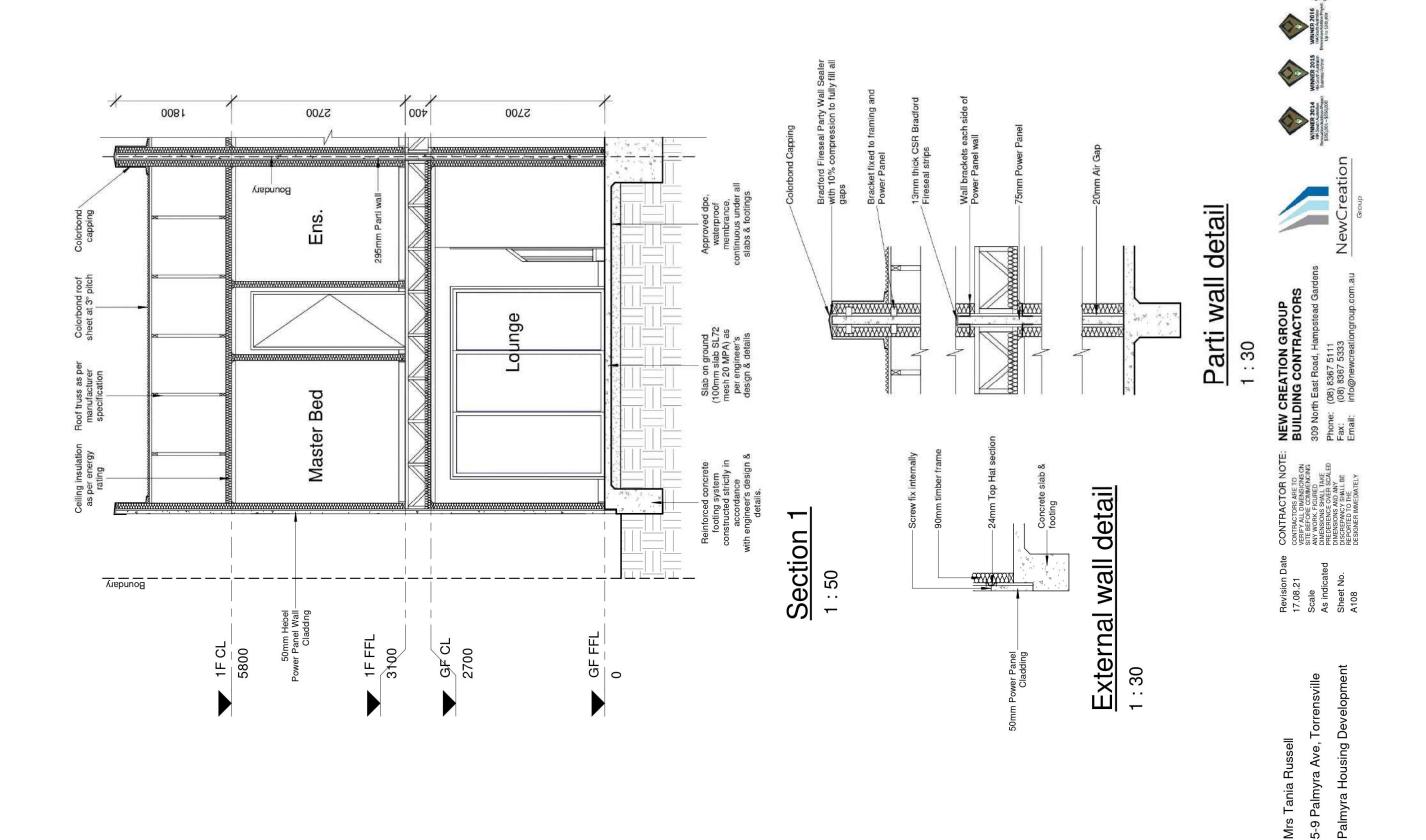
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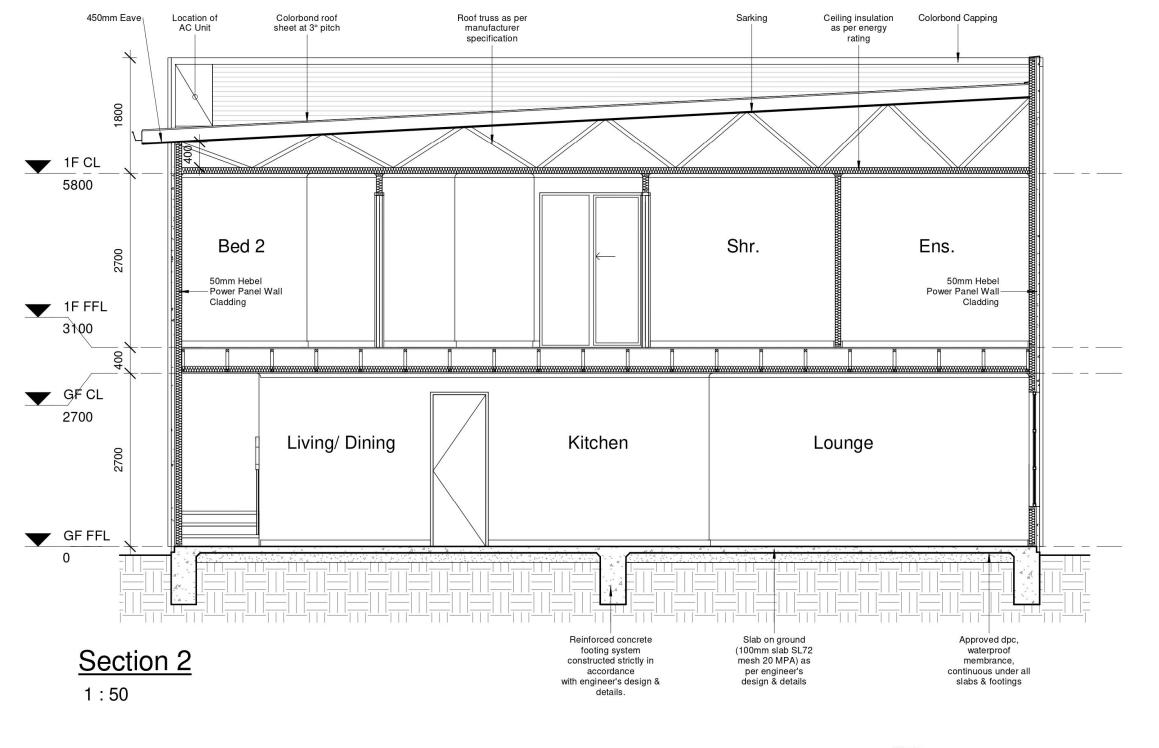
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5-9 Palmyra Ave, Torrensville Palmyra Housing Development Revision Date 17.08.21 Scale 1:50

A109

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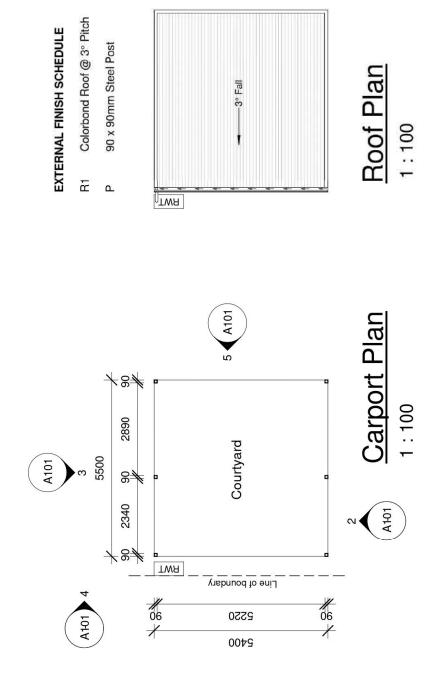








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9 November 2021



TWA

-₹

5400

Carport CL 2400

Carport FFL


Boundary



1:100

Side Elevation 1

1:100

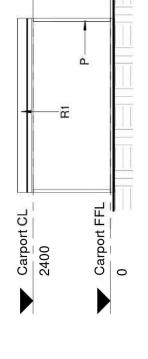

- 5

Carport CL 2400

Carport FFL

Front Elevation 1:100

Rear Elevation

1:100

UNIT 17 CARPORT

Palmyra Housing Development 5-9 Palmyra Ave, Torrensville Mrs Tania Russell

Revision Date 02.08.21 Scale As indicated Sheet No.


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Email: info@newcreationgroup.com.at










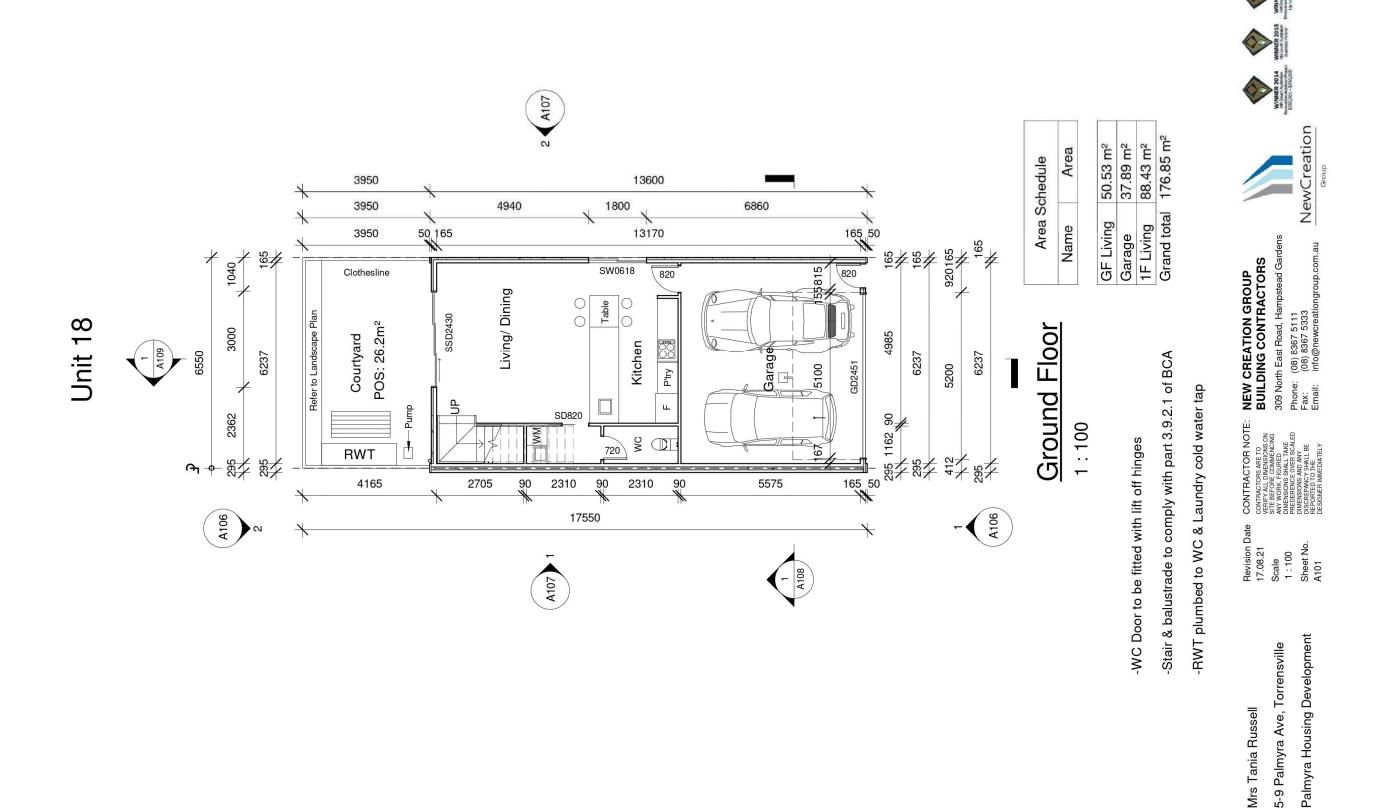

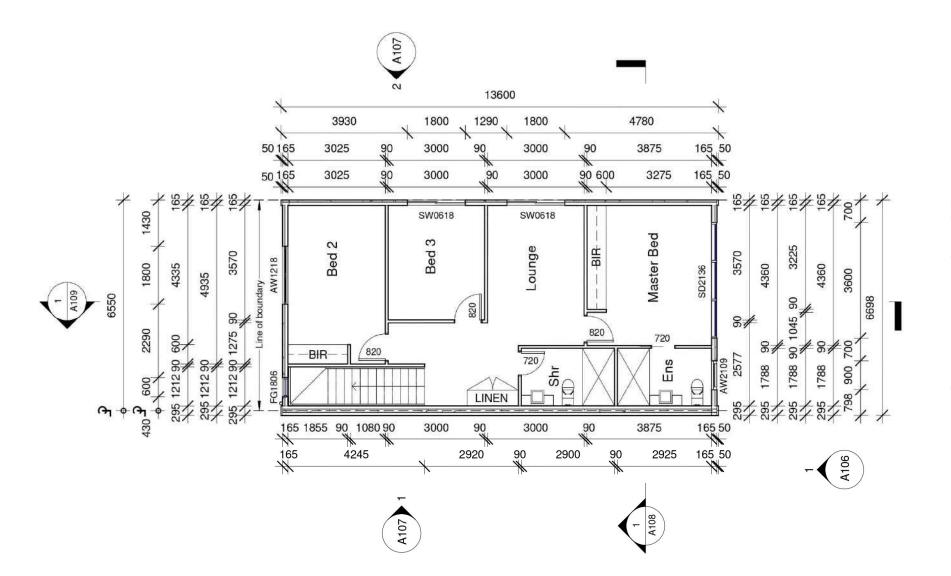



Area

Name

Area Schedule



50.53 m² 37.89 m² 88.43 m² 176.85 m²

GF Living
Garage
1F Living
Grand total

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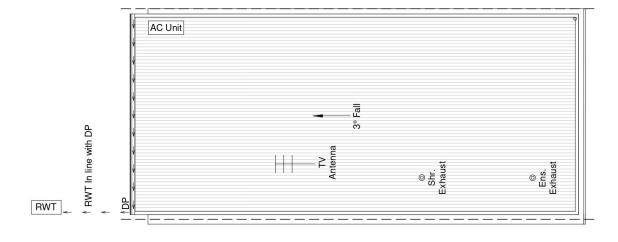
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Revision Date 17.08.21 Scale 1:100 Sheet No. A102

Palmyra Housing Development 5-9 Palmyra Ave, Torrensville

Mrs Tania Russell



Roof Plan 1:100


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Palmyra Housing Development

5-9 Palmyra Ave, Torrensville

Mrs Tania Russell

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Email: info@newcreationgroup.com.au

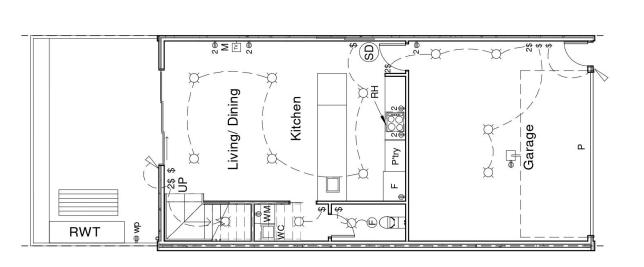

- Ceiling mounted smoke detector hard wired with battery back up
- LED Downlight
- 240 volt power outlet
- 240 volt double power outlet
- Wall switch 8
 - Exhaust $\qquad \qquad \square$
- Σ
- TV Point 2
- ewp 240 volt double weather proof power outlet
- Sensor light

Ground Floor Electrical Layout

1:100

5-9 Palmyra Ave, Torrensville Mrs Tania Russell

Revision Date 17.08.21 Scale 1:100 Sheet No. A104

Palmyra Housing Development

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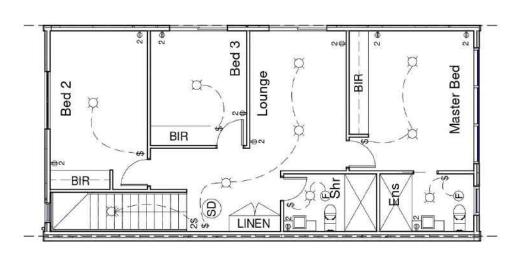












Electrical Legend

- Ceiling mounted smoke detector hard wired with battery back up
 - LED downlight

Ø

- 240 volt power outlet •
- 240 volt double power outlet
- Wall switch ↔

2⊕

Exhaust Fan (H)

1st Floor Electrical Layout

1:100



CONTRACTOR NOTE:
CONTRACTOR ARE TO
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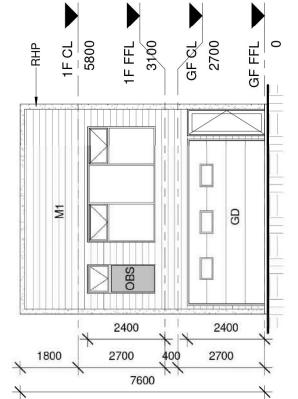


Palmyra Housing Development 5-9 Palmyra Ave, Torrensville

Mrs Tania Russell

Revision Date 17.08.21 Scale 1:100 Sheet No. A105

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COLOUR SCHEDULE


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EXTERNAL FINISH SCHEDULE

- Rendered 50mm Hebel Power Panel Cladding RHP
- Scyon Stria Cladding Σ
- 2.4m x 5.1m Panel Lift Door GD

Front Elevation

1:100

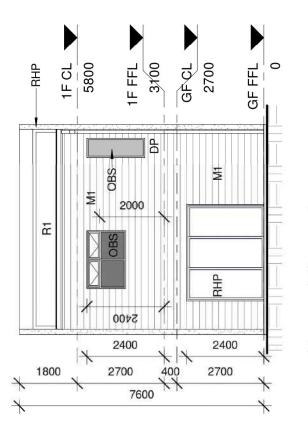

Rear Elevation

1:100

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Palmyra Housing Development 5-9 Palmyra Ave, Torrensville

Mrs Tania Russell


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1F CL 5800

3100

GF CL 2700

1F FFL

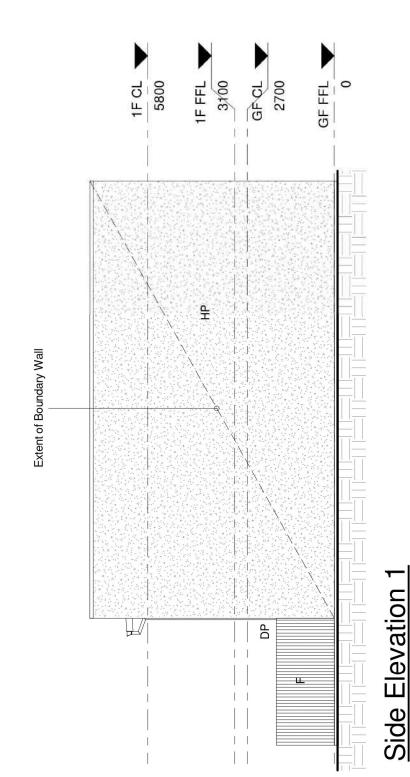

1:100

ш PP 1800 표 2 Side Elevation 2400 5400 2400 2400

GF FFL

0

1:100

EXTERNAL FINISH SCHEDULE

- Rendered 50mm Hebel Power Panel Cladding RHP
- Obscured Glazing OB
- 1.8m H Good Neighbour Colorbond Internal parti fence. Colour: Woodland Grey or similar

Revision Date 17.08.21 Scale As indicated Sheet No. A107 Palmyra Housing Development 5-9 Palmyra Ave, Torrensville Mrs Tania Russell

CONTRACTOR NOTE:

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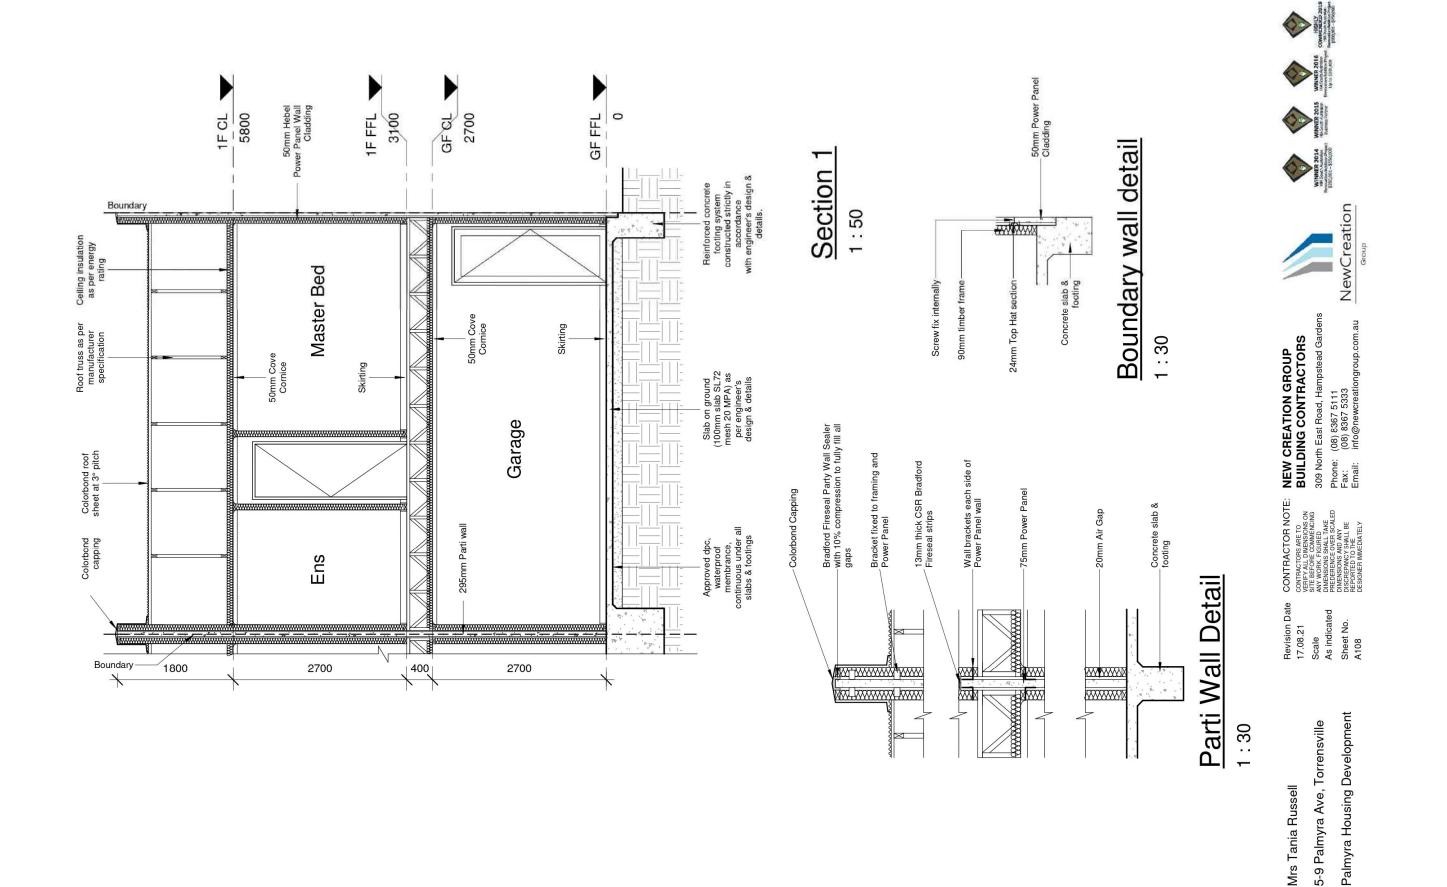
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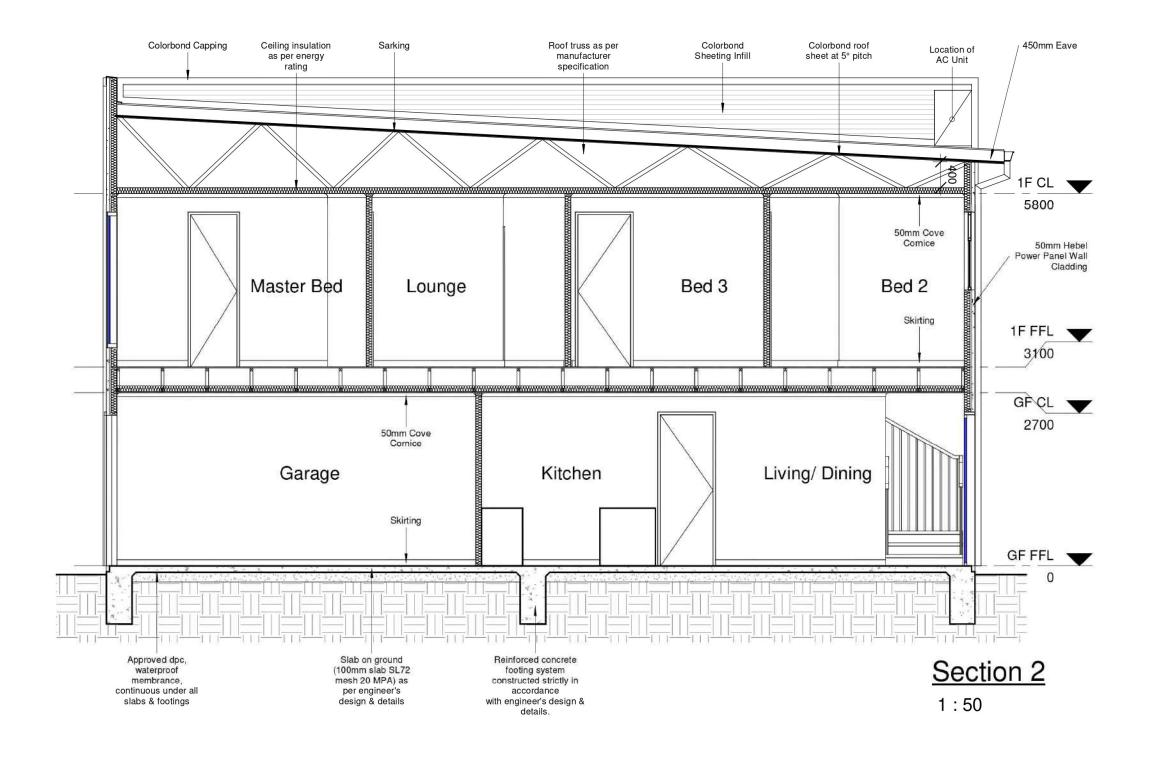
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Mrs Tania Russell

5-9 Palmyra Ave, Torrensville

Palmyra Housing Development

17.08.21 Scale

1:50 Sheet No. A109

Revision Date CONTRACTOR NOTE: NEW CREATION GROUP CONTRACTOR NOTE
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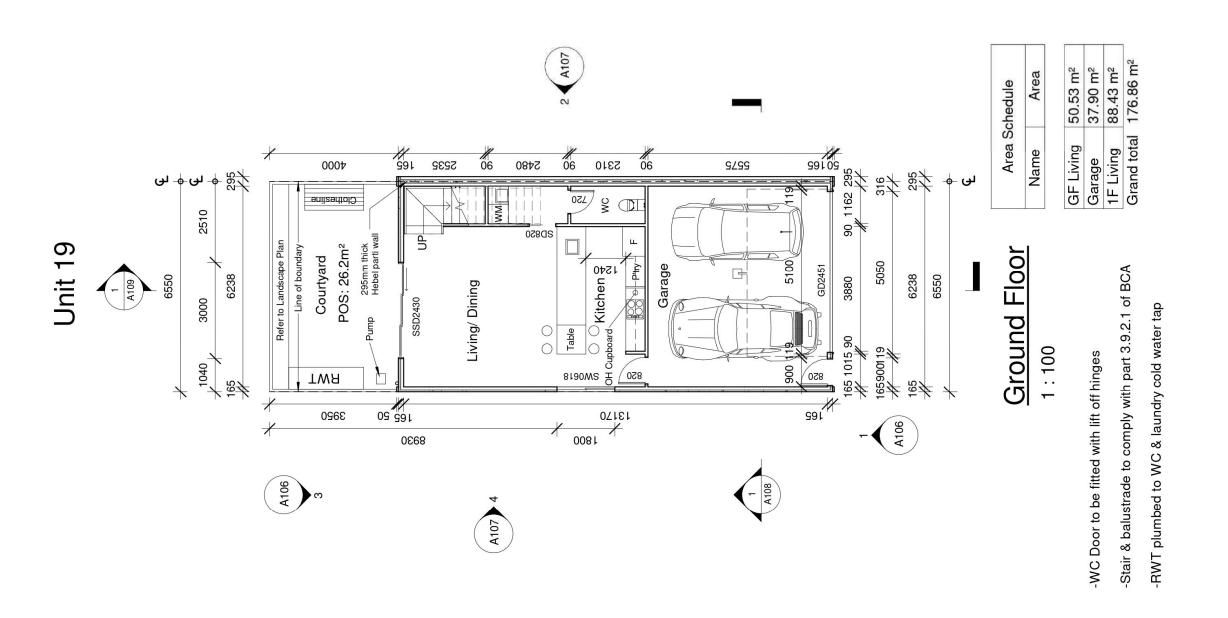








9 November 2021 Page 89



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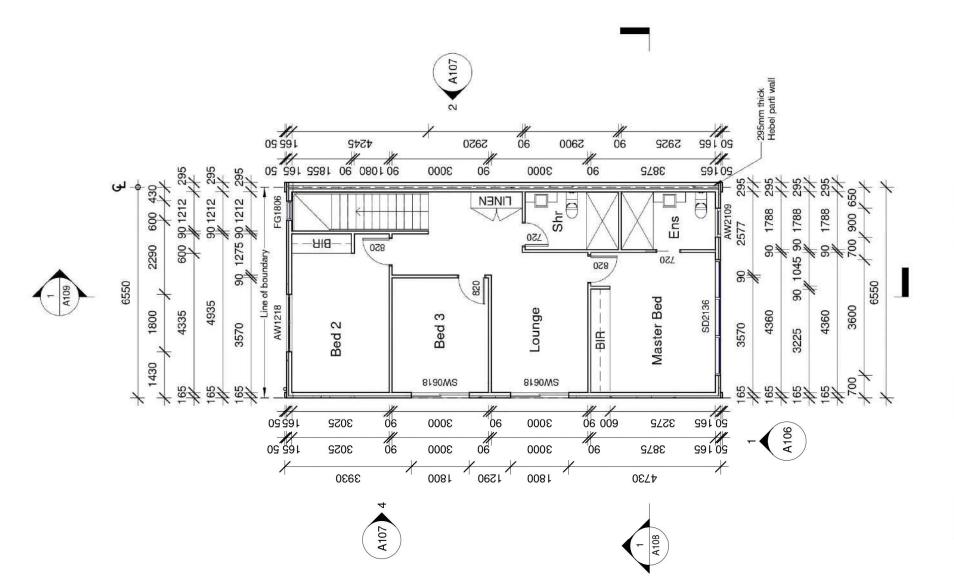
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Palmyra Housing Development 5-9 Palmyra Ave, Torrensville

Mrs Tania Russell

CONTRACTORS ARE TO VEHEY ALL DIMENSIONS ON STEE BEFORE COMMENCING ANY WORK FIGURED MENSIONS SALL TAKE PREDIETENCE OVER SCALED DISCREPANCY SHALL BE PREPARED TO SHALL BE PREPARED TO SHALL BE PREPARED TO SHALL BE PREPARED TO SHALL BE CONSIDER MARTINET OF SHALL BE CONSIDER MARTINET OF SECURITY OF SHALL BE CONSIDER MARTINET OF SECURITY OF SHALL BE PREPARED TO SHALL BE

Revision Date 17.08.21 Scale 1:100 Sheet No.



1st Floor 1:100

Area

Name

Area Schedule

50.53 m² 37.90 m² 88.43 m² 176.86 m²

GF Living
Garage
1F Living
Grand total

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CONTRACTOR NOTE: Revision Date 17.08.21 Scale 1:100 Sheet No. A102

Palmyra Housing Development 5-9 Palmyra Ave, Torrensville

⊚ Shr. Exhaust

© Ens. Exhaust

Roof Plan

1:100

AC Unit

RWT In line with DP

TWA























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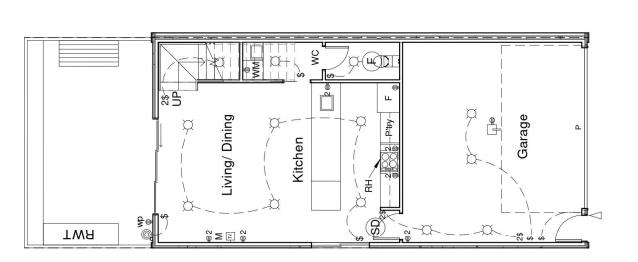
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Palmyra Housing Development

5-9 Palmyra Ave, Torrensville

Mrs Tania Russell

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Electrical Legend

- Ceiling mounted smoke detector hard wired with battery back up
- LED Downlight
- 240 volt power outlet
- 240 volt double power outlet
- Wall switch
- Exhaust (II)
- Outdoor LED light 0
- Modem Σ
- TV Point 2
- 240 volt double weather proof power outlet dw ⊕
- Sensor light
- Rangehood Ä
- Automated Panel lift door

Ground Floor Electrical Layout

1:100

Palmyra Housing Development Mrs Tania Russell

5-9 Palmyra Ave, Torrensville

Revision Date 17.08.21 Scale 1:100 Sheet No. A104

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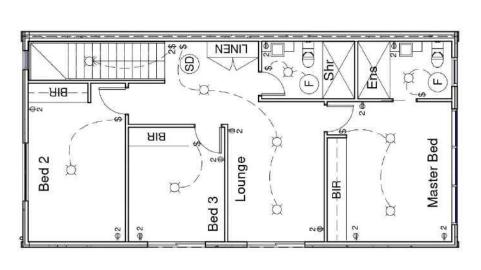












Electrical Legend

- Ceiling mounted smoke detector hard wired with battery back up
 - LED Downlight Ø
- 240 volt power outlet
- 240 volt double power outlet Φ 2⊕
 - Wall switch ↔
- Exhaust (H)

1st Floor Electrical Layout

1:100



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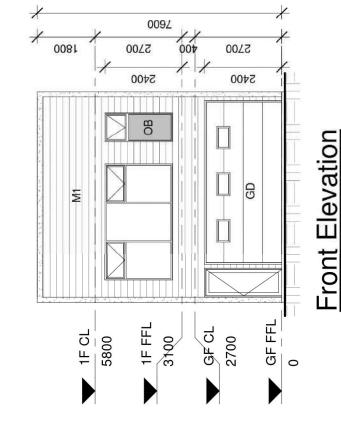






Palmyra Housing Development 5-9 Palmyra Ave, Torrensville Mrs Tania Russell

Revision Date 17.08.21 Scale 1:100 Sheet No. A105



1800 E 1:100 1F CL

0092 000 2700 2700 5400 5400 \uparrow ₹ GF FFL 1F FFL TO 45 5800 3100 2700 0

Rear Elevation 1:100

COLOUR SCHEDULE

Powder coated satin black Gliderol Hampton Surfmist Rev Roofing Surfmist Rev Roofing Surfmist Dulux Natural White Dowel Satin Black Dowel Satin Black Dowel Satin Black PGH Tribeca Red Traditional Single Dulux Monument Dulux Monument Dulux Surfmist **Dulux Surfmist Brighton Light** Satin Black Surfmist Surfmist Sectional Garage Door Windows Aluminium Fly Screen & Doors Framed Glass Balustrade Aluminium Sliding Doors Sectional Garage Door Front Fence (1.2m H) Aluminium Windows Face Brick Cladding Front Door Frame Grout Flush Joint Render Finish Metal Fascia Eave Lining Downpipes Front Door Meter Box Roofing Gutters

EXTERNAL FINISH SCHEDULE

Surfmist or similar

Rainwater tank

Rendered 50mm Hebel Power Panel Cladding 품

Scyon Stria Cladding Ξ

2.4m x 4.8m Panel Lift Door GD OB

Obscure Glazing

NEW CREATION GROUP BUILDING CONTRACTORS

CONTRACTOR NOTE:

Revision Date 17.08.21

Scale As indicated Sheet No. A106

Palmyra Housing Development


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Mrs Tania Russell

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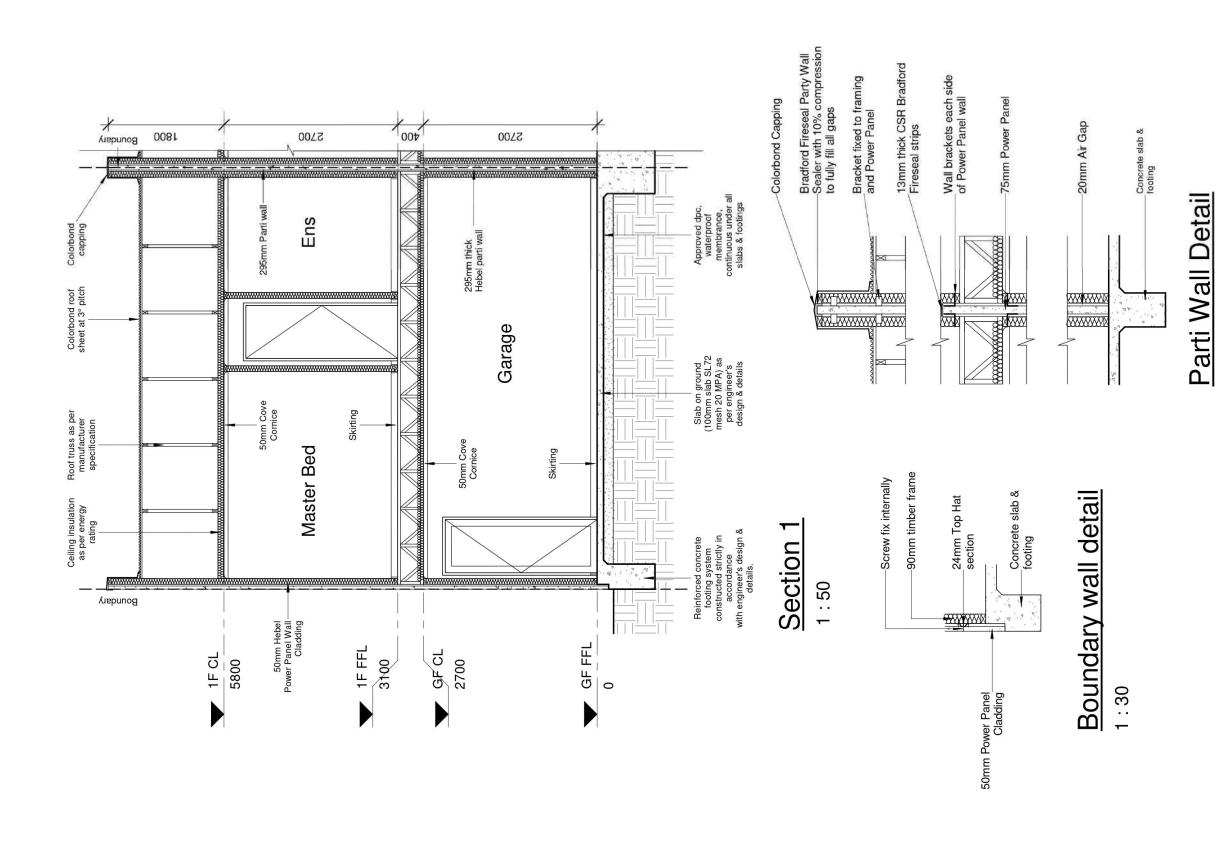
Palmyra Housing Development

5-9 Palmyra Ave, Torrensville

Mrs Tania Russell

CONTRACTOR NOTE:
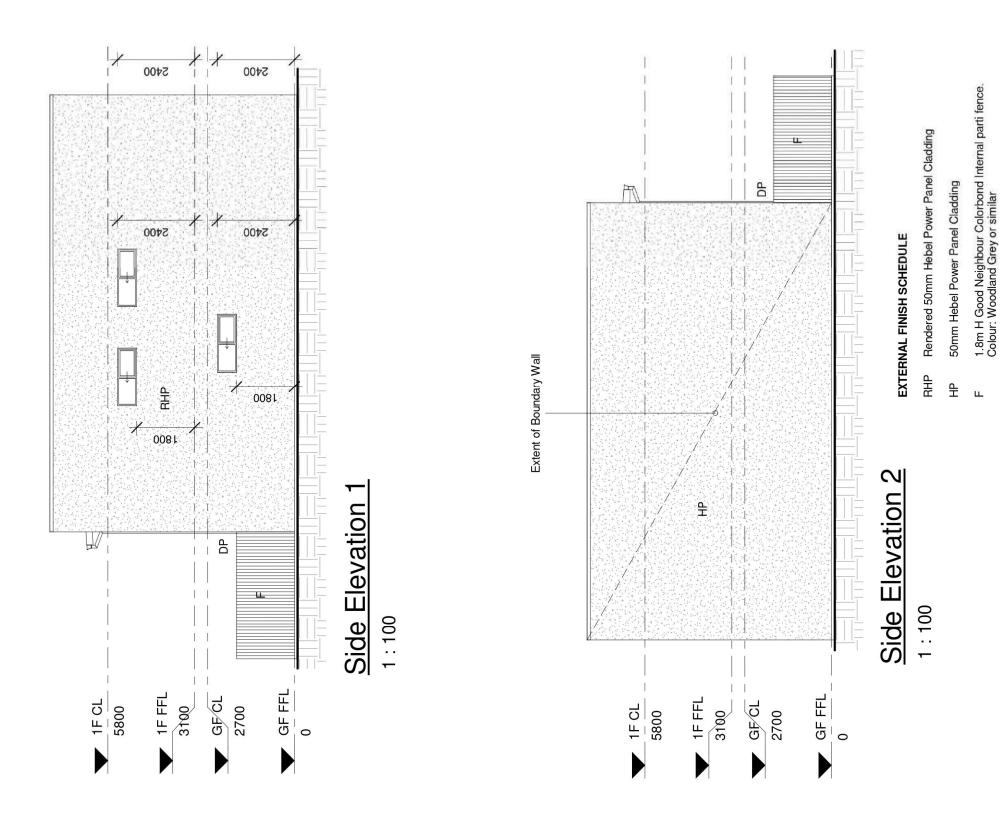
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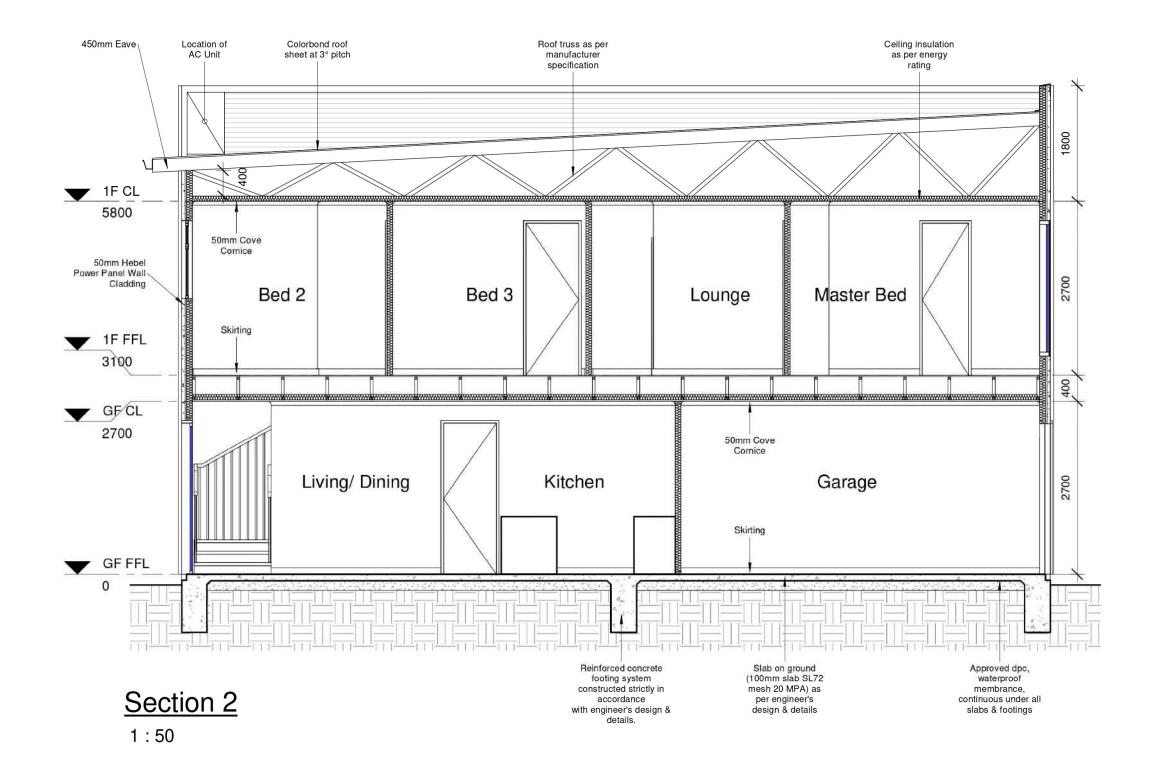
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1:30

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Palmyra Housing Development 5-9 Palmyra Ave, Torrensville

Mrs Tania Russell



Mrs Tania Russell

5-9 Palmyra Ave, Torrensville

Palmyra Housing Development

17.08.21 Scale

CONTRACTOR NOTI.
CONTRACTORS ARE TO YERRY ALL DIMENSIONS ON SITE BEFORE COMMENCING ANY WORK FIGURED DIMENSIONS SHALL TAKE PREDERENCE OVER SCALED DIMENSIONS AND ANY DISCREPANCY SHALL BE REPORTED TO THE DESIGNER IMMEDIATELY. 1:50 Sheet No. A109

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DWELLINGS 1-8 BOUNDARY LOCATION OF GAS/ ELECTRICAL UNITS LOCATION OF LETTERBOXES

Front Streetscape

1:150

Mrs Tania Russell

5-9 Palmyra Ave, Torrensville

Palmyra Housing Development

01.11.21 Scale

1:150 Sheet No. A106

CONTRACTOR NOTE
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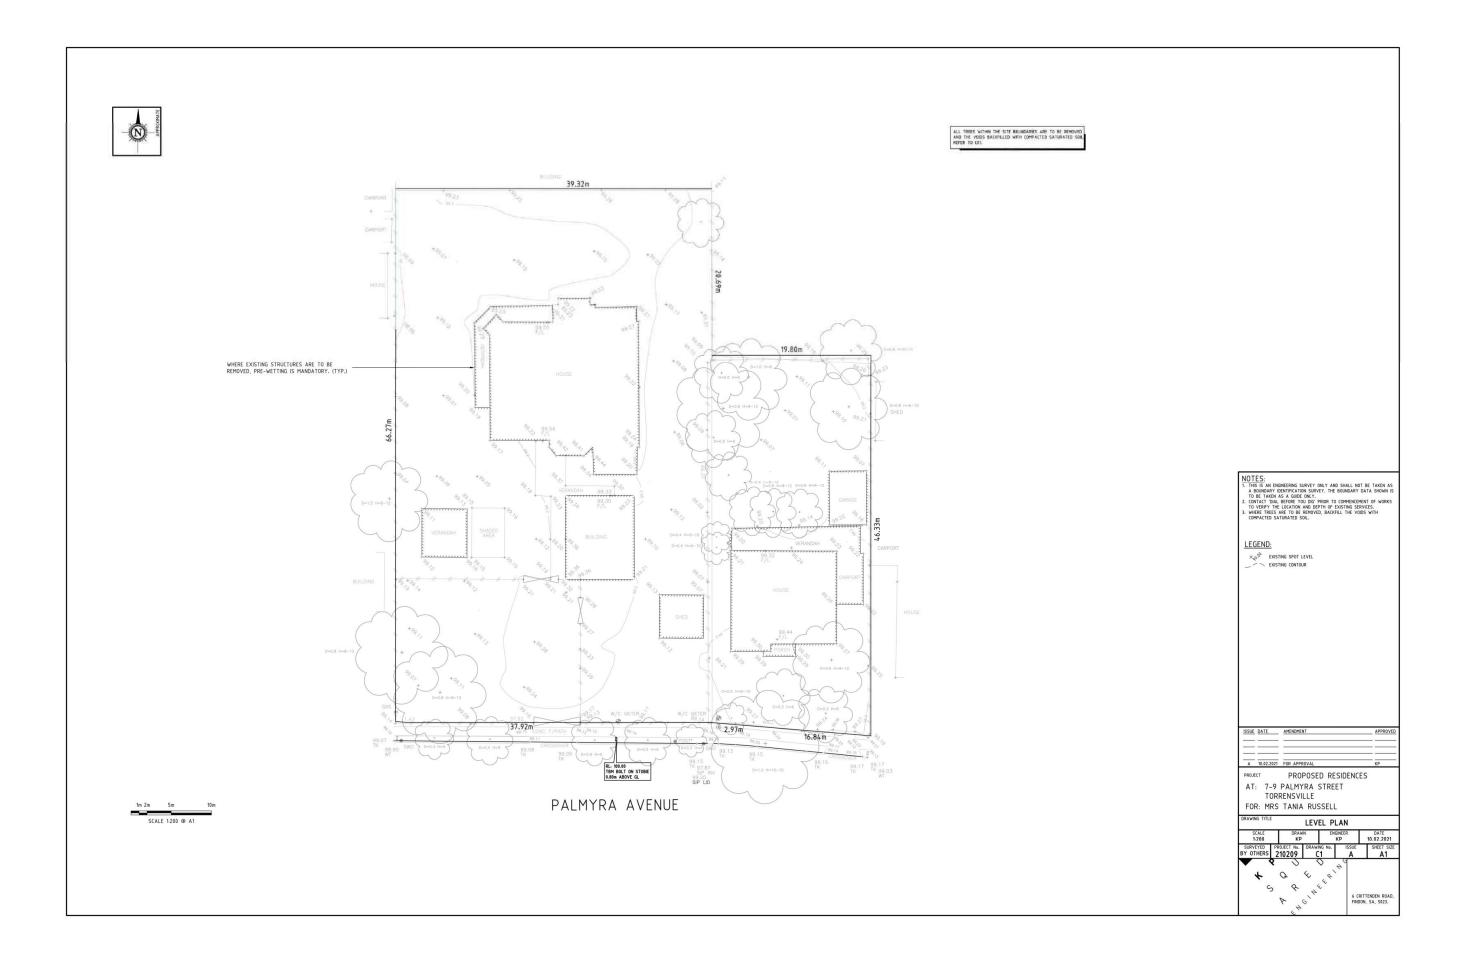












9 November 2021 Page 99



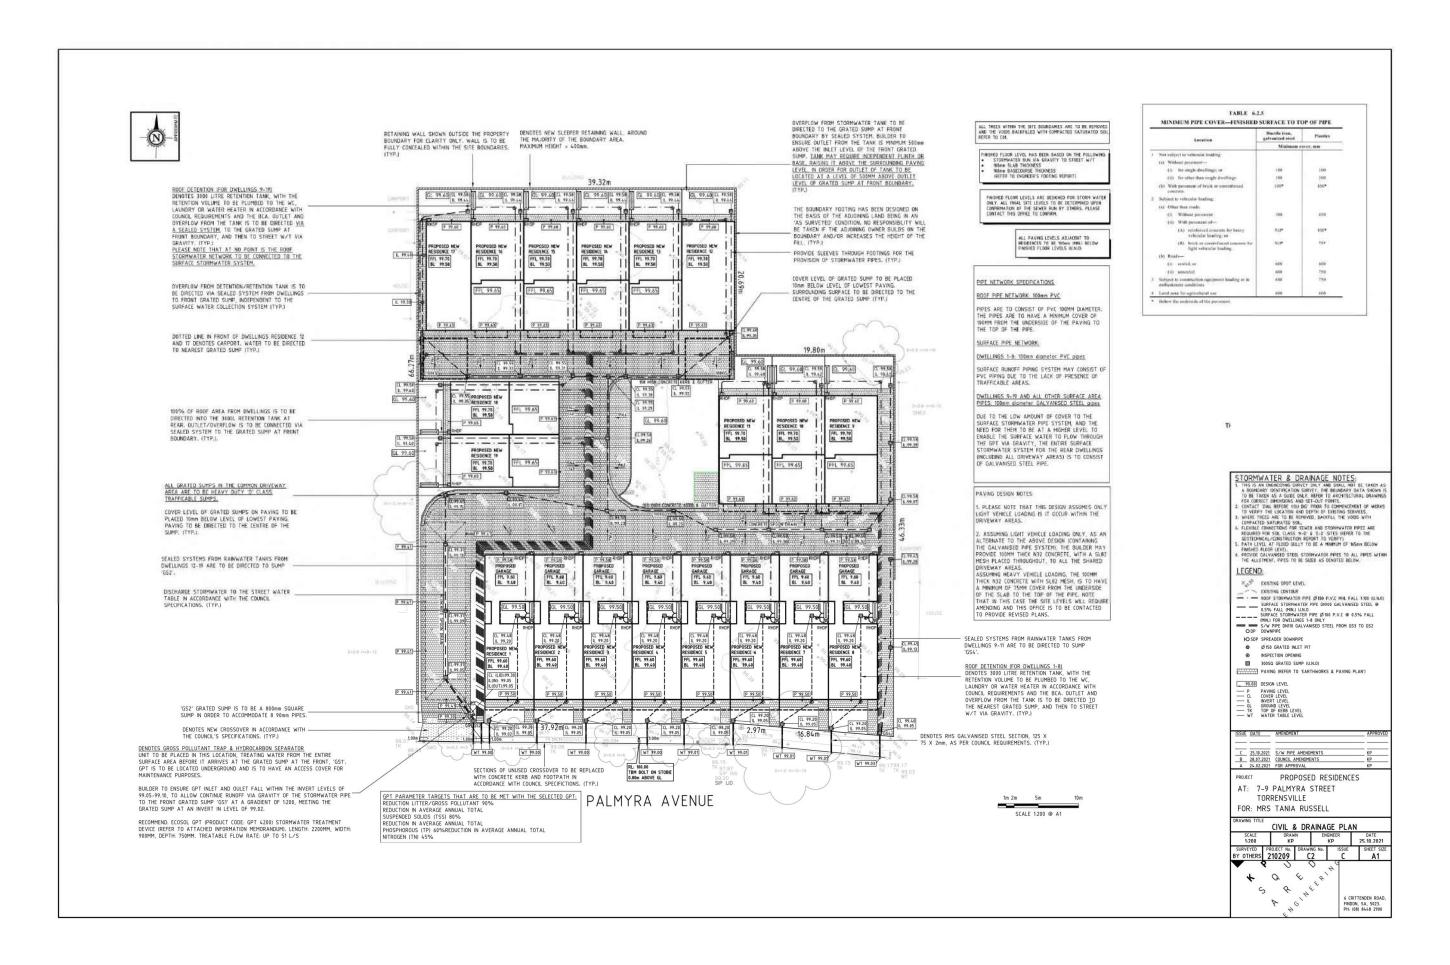

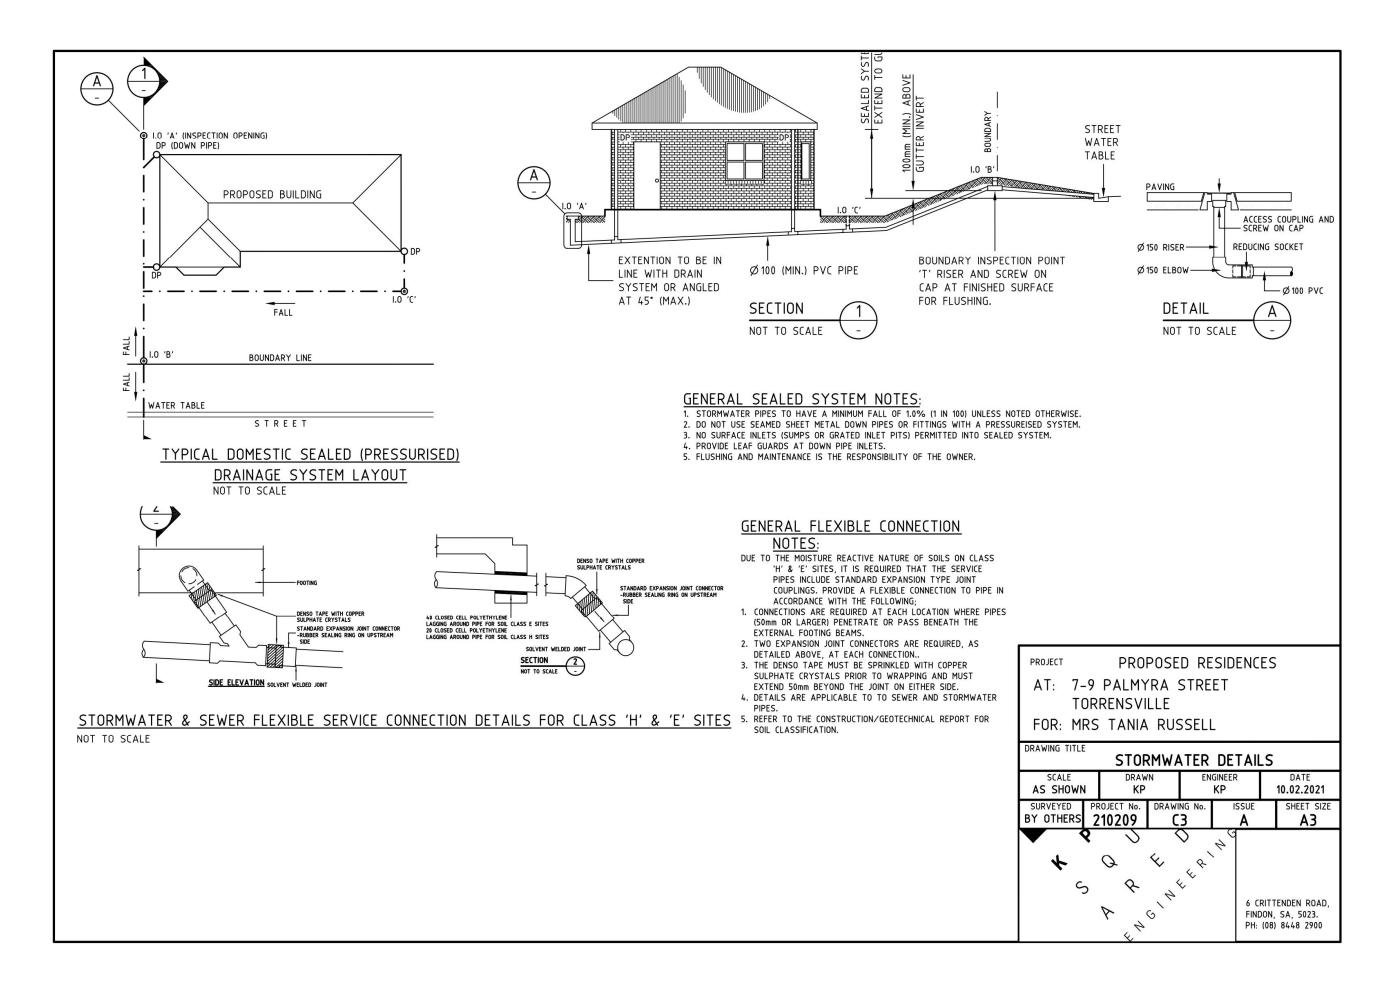

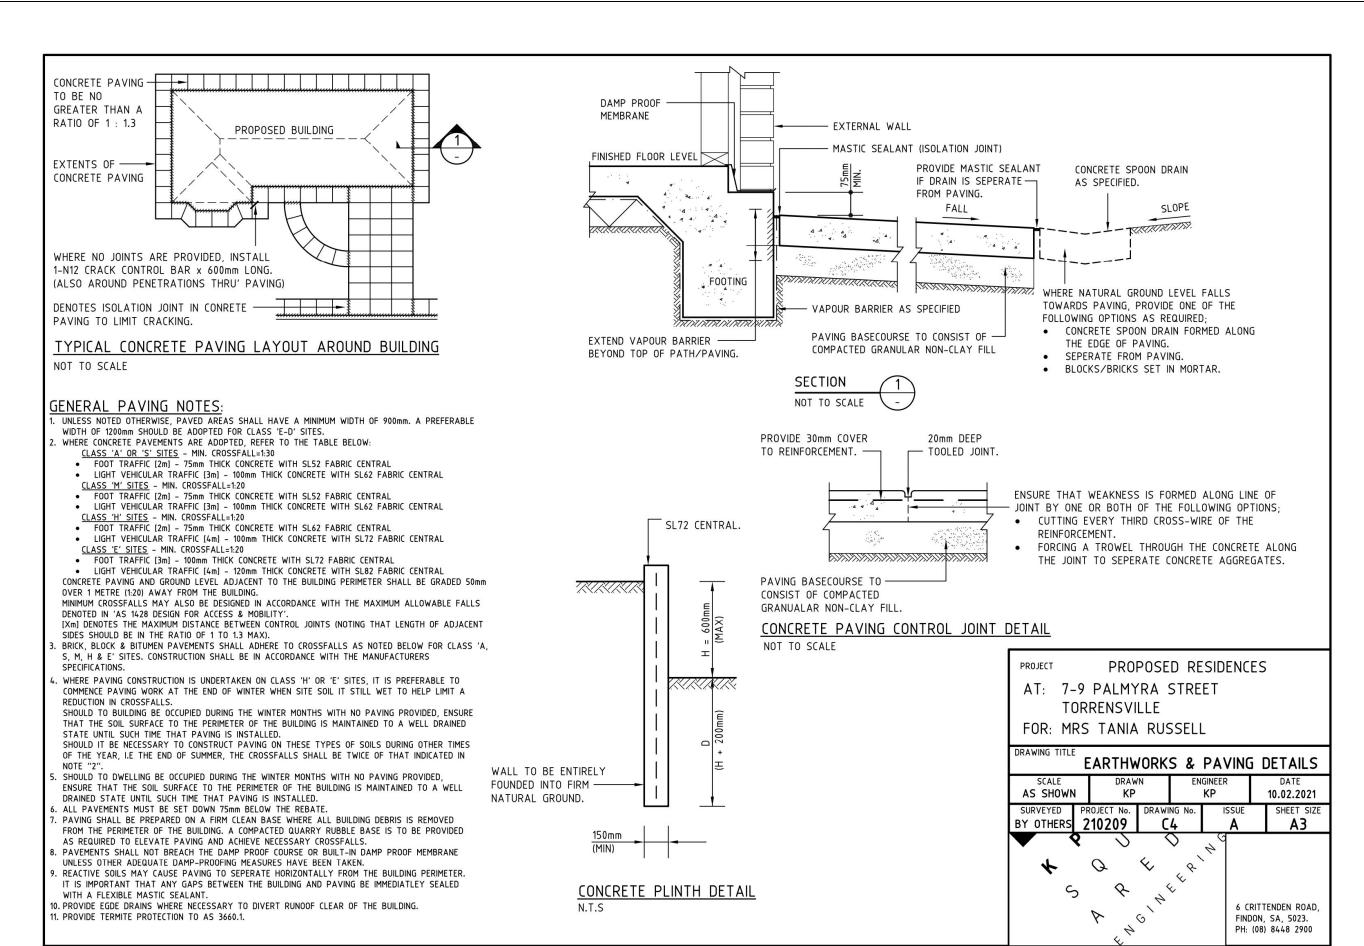

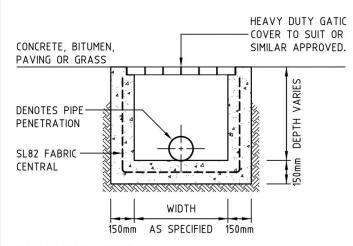


GRATED SUMP

1:20

NOTES

- REFER TO 'STORMWATER PIT SCHEDULE' FOR PIT DIMENSIONS.
- 2. PENETRATION FOR PIPES SHALL BE APPROX. 50mm GREATER THAN THE OVERALL DIAMETER OF PIPE. PIPES SHALL BE FINISHED FLUSH WITH THE INTERNAL FACE OF THE SUMP. A STIFF MORTAR MIX SHALL BE PACKED INTO THE SPACE FROM BOTH SIDES OF STRUCTURE. THE INTERNAL FACE SHALL BE FINISHED SMOOTH AND A 150mm THICK BAND ON CONCRETE SHALL BE POURED OUTSIDE THE SUMP TO SEA THE PENETRATION.
- 3. WHERE SUMPS CONSIST OF MORE THAN ONE PRECAST UNIT, THE JOINTS SHALL BE SEALED WITH BUTYL MASTIC FLEXIBLE PIPE SEALANT AROUND THE OUTSIDE AND A 1:3 SAND CEMENT GROUT ON THE INSIDE OF THE SUMP.

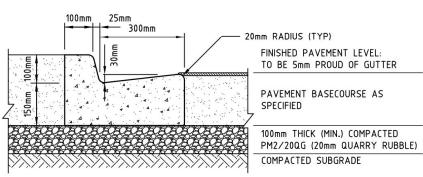


100mm HIGH KERB & GUTTER

1:10

NOTE:


PROVIDE 10mm WIDE x 20mm DEEP TOOLED JOINTS AT 3.0m CRS (MAX.) FORCE A TROWEL THOUGH JOINTS DURING CONCRETE POUR TO SEPARATE AGGREGATES AND INFLUENCE CRACKING AT THESE LOCATIONS.

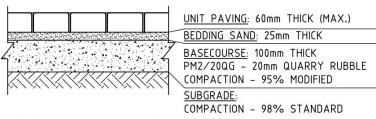

UNIT PAVEMENT

NON-VEHICULAR DUTY


1:10

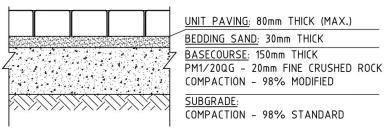

UNIT PAVEMENT

VEHICULAR DUTY

1:10

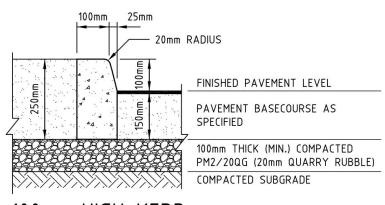



100mm HIGH KERB

1:10

NOTE:

PROVIDE 10mm WIDE x 20mm DEEP TOOLED JOINTS AT 3.0m CRS (MAX.) FORCE A TROWEL THOUGH JOINTS TO SEPARATE AGGREGATES AND INFLUENCE CRACKING AT THESE LOCATIONS.

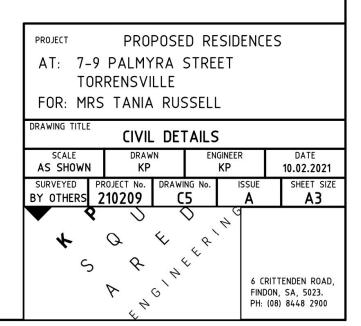

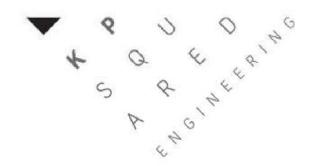

STORMWATER DESIGN CALCULATIONS

PROJECT ADDRESS: 7-9 PALMYRA STREET, TORRENSVILLE

COUNCIL: CITY OF WEST TORRENS

JOB NUMBER: 210209

DATE: 10 FEBRUARY 2021

ISSUE:

CONTACT DETAILS: KP Squared Engineering Pty Ltd

6 Crittenden Road, Findon, SA, 5023.

PH: (08) 8448 2900

Project	7-9 Palmyra Street, Torrensville, SA, 5031 [-34.925032, 138.556344] [34°55'30.1"S 138°33'22.8"E]		Designed in accordance ARR 2019, AS/NZS 35 and related engineering	500.3:2018,		Page Job No. Date Eng	CC1/A 210209 10/02/21 KP
1:20 ARI (5 minute duration) Total Site Area		i = A =	121 3531.73	mm/hr m²	(5 minute duration)		
Runoff Calculations							
Council Requirements: For proposed development totalist between 1000 and 4000 square metres, stormwater detention measures are required to limit the peak discharge rate for the critical 20 year ARI storm event to the equivalent predevelopment 20 minute storm with a 0.25 runoff coefficient applied to the site. Pre-development runoff							
Impervious Area -		Ai =	684	m^2	Ci =	0.9	
Pervious Area -		Ap =	2847.73	m ²	Cp = Cn = Cn =	0.1 [(Ci x Ai) + (Cp x Ap)]/A 0.25	
Flow Rate -		Q ₂₀ =	(Cn x i x A)/3600				
		Q _{pre} =	29.68	Litres/sec			

-Therefore we must limit post-development outflow to 29.68 litres/second.

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Post-development surface schedule

Impervious Area (Roof)	Ari =	1758.05	m^2
Impervious Area (Paving)	Api =	1074.78	m^2
Pervious Area (Landscaping)	Alp =	698.90	m^2
Section 1 (Dwellings 1-8)			
Total Section Area	A =	1081.51	\mathbf{m}^2
Impervious Area (Roof)	Ari =	782.4	m^2
Impervious Area (Paving)	Api =	115.44	\mathbf{m}^2
Pervious Area (Landscaping)	Alp =	183.67	m ²
Section 2 (Dwellings 9-11)			
Total Section Area	A =	395.97	\mathbf{m}^2
Impervious Area (Roof)	Ari =	266.9	m^2
Impervious Area (Paving)	Api =	46.59	m^2
Pervious Area (Landscaping)	Alp =	82.48	m ²
Section 3 (Dwellings 18-19)			
Total Section Area	A =	230.65	m^2
Impervious Area (Roof)	Ari =	177.93	m^2
Impervious Area (Paving)	Api =	11.86	m^2
Pervious Area (Landscaping)	Alp =	40.86	m ²
Section 4 (Dwellings 12-17)			
Total Section Area	A =	688.1	m^2
Impervious Area (Roof)	Ari =	530.82	m^2
Impervious Area (Paving)	Api =	35.39	\mathbf{m}^2
Pervious Area (Landscaping)	Alp =	121.89	m ²
Section 5 (Shared Driveway + Landscaping)			
Total Section Area	A =	1135.5	m^2
Impervious Area (Roof)	Ari =	0	m^2
Impervious Area (Paving)	Api =	865.5	m^2
Pervious Area (Landscaping)	Alp =	270.00	m^2
5 5 152			

Post-development runoff

Surface Runoff (Uncontrolled from Dwellings 1-8) Total Area	A =	299.11	m²		
Impervious Area (Paving) Pervious Area (Landscaping)	A = A =	115.44 183.67	$m^2 \ m^2$	Ci=	0.9
	$Q_{surface} = Q_{surface}$	(Cn x i x A)/3600 4.12	Litres/sec	Cp = Cn = Cn =	0.1 [(Ci x Ai) + (Cp x Ap)]/A 0.41
	Q _{surface} =	4.12	Litres/sec		

Therefore, as 4.12 l/s is uncontrolled flow from the front 8 dwellings (1-8), and the maximum allowable flow from the site is to be limited to 29.68 l/s, then the surface water from the rear eleven dwellings (9-19) and the common driveway is to be limited to 15.06 l/s and the remaining allowable flow of 10.50 l/s is to be divided between the nineteen dwellings for the roof runoff, that is, the runoff from the roof area of each dwelling is to be limited to 0.50 l/s.

urface Runoff (Controlled from 11 rear dwellings + common driveway)						
Total Area		A =	1474.57	m²		
Impervious Area (Paving)		A =	959.34	m²	Ci=	0.9
Pervious Area (Landscaping)		A =	515.23	m^2		
		Q _{surface} =	(Cn x i x A)/3600		Cp =	0.1
		Q _{surface} =	30.73	Litres/sec	Cn = Cn =	[(Ci x Ai) + (Cp x Ap)]/A 0.62
		Q _{surface} =	30.73	Litres/sec		
Allowed Surface Runoff		Qsurface _(allowed) =	15.06	Litres/sec		
Area remaining Coeff Permeability	1474.57 0.62	m²				
Time of conc. ARI Storm	5 20 year	min				
Max Outflow Qp	15.06	l/sec				
		Q _{surface} =	30.7284003889	Litres/sec		

PROVIDE	4700	LITRES	OF SURFACE DETENTION	ON WITH A	<u>110</u>	mm ORIFICE.	
Diameter =	0.110	m =	110.0	mm			
A =	$(\pi \times D^2)/4$						
A =	0.0094694541	m ²		A =	?	H =	
Q _{max} =	$0.6 \times A \sqrt{(2 \times g \times H)}$		where	$Q_{max} =$	0.0151	g =	
_				0			7
Orifice Design					Both ends of cell to be have directing the water to the co		
Total amount of seconds to empty	312.0849933599	seconds	:<24 hours, therefore Ol	K)	Volume: 5050L	vo 2 50m long bottors	
Flow rate per second	15.06	Litres			Width: 5.00m		
Detention cell volume	4700	Litres			Depth: 0.10m		
,					Length: 22.00m	_	
Check to ensure detention tank emptied in 24 hours					Detention Cell Dimension	ns	7
Flow rate (from surface cell)		Q _{orifice (tank)} =	15.06	Litres/sec			
Detention Required (Entire Site)			4700	Litres			
Surface Detention Required							
3 Hour	10000	14.5	3.0310302270	33220.01200	-120427.30714		
2 hour 3 hour	7200 10800	19 14.3	4.8251207222 3.6315382278	34740.8692 39220.61286	-73691.1308 -123427.38714		
1.5 hour	5400 7300	23.1	5.8663309833	31678.18731	-49645.81269		
1 hour	3600	30.2	7.6694024111	27609.84868	-26606.15132		
45 min	2700	36.4	9.2439154889	24958.57182	-15703.42818		
30 min	1800	46.9	11.9104295722	21438.77323	-5669.22677		
25 min	1500	52.5	13.3325704167	19998.855625	-2591.144375		
20 min	1200	59.9	15.2118279611	18254.19355333			
15 min	900	70.6	17.9291327889	16136.21951	2582.21951		
10 min	600	87.6	22.2463460667	13347.80764	4311.80764		4
5 min	300	121	30.7284003889	9218.520116667	4700.5201166667	Critical	1
4 min	240	131	33.2679376111	7984.305026667	4369.9050266667		
3 min	180	145	36.8232897222	6628.19215	3917.39215		
2 min	120	163	41.3944567222	4967.334806667	3160.1348066667		
1 min	60	186	47.2353923333	2834.12354	1930.52354		
Duration min	Duration seconds	Intensity mm/hr	Inflow rate Ip I/sec	Inflow Vol Vi m3	Max Storage Smax m3		

PROVIDE	<u>1000</u>	LITRES OF D	DETENTION (PER DWE	LLING) WITH A		<u>17</u>	mm ORIFICE.
DDO//DF	4000	LITBES OF	DETENTION / DED DWE	I I INC) WITH A		47	mm ODICIOE
Diameter =	0.017	m =	17.0	mm			
A =	$(\pi \times D^2)/4$						
. • =		•••			-	• • •	•
A =	0.0002257618	m^2		A =	?	H =	1
Q _{max} =	$0.6 \times A \sqrt{(2 \times g \times H)}$		where	$Q_{max} =$	0.0006	g =	9.81
Simos Dodyn							
Orifice Design							
Total amount of seconds to empty	1808.777	seconds	<24 hours, therefore C	PK)			
Flow rate per second	0.5526315789	Litres		10			
Detention tank volume (per dwelling)	999.5872894737	Litres					
Chook to ensure determion tank emplied in 24 nours							
Check to ensure detention tank emptied in 24 hours							
Flow rate (per dwelling)		Q _{orifice (tank)} =	0.5526315789	Litres/sec			
Detention (per dwelling)		Detention =	999.5872894737	Litres			
Dwellings			19	Dwellings			
Detention Required (Entire Site)			18992.1585	Litres			
Roof Detention Required							
Doof Dotomica Beauties							
3 hour	10800	14.3	6.28502875	67878.3105	-45521.6895		
2 hour	7200	19	8.3507375	60125.31	-15474.69		
1.5 hour	5400	23.1	10.15273875	54824.78925	-1875.21075		
1 hour	3600	30.2	13.2732775	47783.799	9983.799		
45 min	2700	36.4	15.998255	43195.2885	14845.2885		
30 min	1800	46.9	20.61313625	37103.64525	18203.64525		
25 min	1500	52.5	23.07440625	34611.609375	18861.609375	Offical	
20 min	1200	59.9	26.32679875	31592.1585	18992.1585	Critical	
15 min	900	70.6	31.0295825	27926.62425	18476.62425		
10 min	600	87.6	38.501295	23100.777	16800.777		
5 min	300	121	53.1810125	15954.30375	12804.30375		
4 min	240	131	57.5761375	13818.273	11298.273		
2 min 3 min	180	145	63.7293125	11471.27625	9581.27625		
1 min 2 min	60 120	186 163	81.749325 71.6405375	4904.9595 8596.8645	4274.9595 7336.8645		
Duration min	Duration seconds	mm/hr	l/sec	m3	Smax m3		
		Intensity	Inflow rate Ip	Inflow Vol Vi	Max Storage]	
		1001	00.1010120	Liticoroco			
		Q _{roof} =	53.1810125	Litres/sec			
Max Outflow Qp	10.50	l/sec					
ARI Storm	20 year						
Time of conc.	Critical	min					
Coeff Permeability	0.9						
Area remaining	1758.05	m^2					
		rool(allowed)	0,000				
Allowed Roof Runoff		Q _{roof(allowed)} =	10.50	Litres/sec			
Roof Runoff							

		Annual Exceedan	ce Probability (AEP)			
Duration	63.20%	50%#	20%*	10.00%	5.00%	2.00%	1.00%
1 min	76.3	87.3	125	155	186	232	272
2 min	67.1	76.6	110	135	163	205	241
3 min	59.8	68.3	97.8	121	145	182	214
4 min	54.1	61.8	88.6	109	131	165	193
5 min	49.6	56.7	81.2	100	121	151	177
10 min	35.9	41.1	59.1	72.8	87.6	109	128
15 min	28.9	33.1	47.5	58.6	70.6	88.1	103
20 min	24.5	28.1	40.3	49.8	59.9	74.8	87.5
25 min	21.5	24.6	35.3	43.6	52.5	65.6	76.7
30 min	19.2	22	31.6	39	46.9	58.7	68.7
45 min	14.9	17.1	24.5	30.2	36.4	45.5	53.3
1 hour	12.4	14.2	20.3	25.1	30.2	37.8	44.2
1.5 hour	9.57	10.9	15.6	19.2	23.1	28.8	33.8
2 hour	7.92	9.02	12.9	15.8	19	23.7	27.7
3 hour	6.05	6.89	9.77	12	14.3	17.9	20.8
4.5 hour	4.61	5.24	7.4	9.04	10.8	13.4	15.5
6 hour	3.8	4.31	6.06	7.38	8.79	10.8	12.6
9 hour	2.87	3.25	4.54	5.52	6.55	8.01	9.22
12 hour	2.35	2.65	3.69	4.47	5.29	6.43	7.37
18 hour	1.75	1.98	2.73	3.29	3.88	4.68	5.32
24 hour	1.42	1.6	2.2	2.64	3.1	3.71	4.2
30 hour	1.2	1.35	1.85	2.21	2.59	3.09	3.48
36 hour	1.05	1.17	1.6	1.91	2.23	2.65	2.98
48 hour	0.839	0.939	1.27	1.51	1.76	2.07	2.32
72 hour	0.612	0.681	0.911	1.08	1.25	1.45	1.61
96 hour	0.488	0.542	0.718	0.843	0.969	1.12	1.24
120 hour	0.411	0.455	0.598	0.697	0.796	0.919	1.01
144 hour	0.357	0.395	0.515	0.597	0.677	0.779	0.857
1 6 8 hour	0.318	0.352	0.455	0.524	0.59	0.677	0.743



Traffic · Parking · Transport

Unit 6, 224 Glen Osmond Road FULLARTON SA 5063

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E: mfya@mfy.com.au
W: mfy.com.au

MFY Pty Ltd ABN 79 102 630 759

JML/20-0075

5 March 2021

Mr Charles Thompson New Creation Group Pty Ltd 309 North East Road HAMPSTEAD GARDENS SA 5086

Dear Charles,

PROPOSED RESIDENTIAL DEVELOPMENT 5-9 PALMYRA AVENUE, TORRENSVILLE

I refer to the proposal for a residential development on the above site. As requested, I have reviewed the parking and traffic implications associated with the proposal. The assessment is based on the New Creation Group Site Plan dated 2 March 2021.

We note that the City of West Torrens (Council) raised several traffic engineering items as part of a preliminary assessment of an earlier iteration of the plans, providing comment on:

- access to/from the garages;
- car parking provision (on-site and on-street);
- · bicycle parking provision;
- · refuse collection; and
- · impacts of services on vehicle manoeuvrability.

The amended plans have been prepared with consideration of these matters, as discussed in this report.

1 EXISTING SITUATION

The site currently consists of two allotments, located within the Transit Living Policy Area 36 and zoned Urban Corridor in Council's Development Plan.

Palmyra Avenue is a local residential road under the care, control and management of Council. The road is kerbed and approximately 7.2 m wide. It has footpaths on both sides of the road and no parking restrictions.

F:\20-0075 CharlesThompson 5 Mar 21.docx

20-0075 5 March 2021 Page 2 of 4



The site is located within 300 m of the existing bus stops on Henley Beach Road, which provides for convenient public transport options for residents or their visitors.

2 THE PROPOSAL

It is proposed to redevelop the site with a group dwelling consisting of 19 three-bedroom residences, each with a double garage. The dwellings will be accessed via a two-way circulation roadway on the western side of the site.

The proposed garage and access road dimensions will comply with the requirements of Australian/New Zealand Standard, *Parking Facilities Part 1: Off-street car parking (AS/NZS 2890.1:2004* (the "Standard"). The garages will be 5.4 m wide with a 4.8 m wide door and 5.4 m long. They will be accessed via an internal roadway that will be at least 5.8 m with an additional 0.3 m clearance to obstructions greater than kerb height such as walls or fences.

Provision has been made for the storage and collection of refuse for the internal dwellings, based on the weekly waste volumes identified in Zero Waste SA's South Australia Better Practice Guide Waste Management for Residential and Mixed Use Developments. Figure 1 illustrates the swept path of a refuse collection vehicle turn on-site and as such, drivers of such vehicles will be able to enter and exit the site in a forward direction.

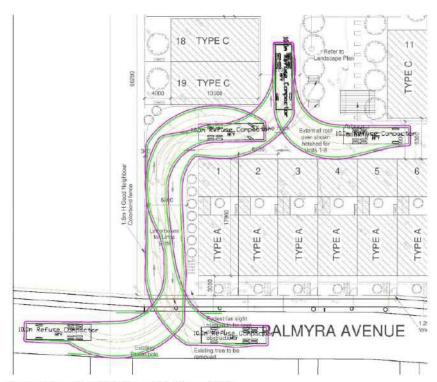


Figure 1: Swept path (refuse collection vehicle)

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The landscaping adjacent to the proposed access point will be low-lying to ensure compliance with sightlines to pedestrians in accordance with Figure 3.3 of the Standard.

3 PARKING DEMAND ASSESSMENT

3.1 VEHICULAR PARKING

3.1.1 On-site parking

Council's Development Plan identifies the following parking requirement within the Urban Corridor Zone:

- · two spaces per three-bedroom dwelling; plus
- 0.25 spaces per dwelling for visitors.

The double garages will satisfy the requirement for two residential parking spaces per dwelling.

The plans do not currently provide for the five on-site visitor parking spaces nominated by the Development Plan. As an alternative, the proposed development includes a central landscaping area. This area would have the capacity to accommodate up to the five on-site parking spaces that are stipulated for visitor parking by the Development Plan but in the event that this is not provided, visitor parking would instead be accommodated on-street.

3.1.2 On-street parking provision

Palmyra Avenue has an existing on-street parking provision for up to 41 vehicles. As a result of the wider crossover associated with this development and proposed parking restrictions to accommodate the swept path for the refuse collection vehicle entering and exit the site (as shown in Figure 1), this provision will reduce by one space on the northern side of the road and one space on the southern side of the road.

Council has referenced the following clause of the Development Plan in its preliminary assessment for the site:

12. On-street vehicle parking should be provided at a ratio of one car parking space for every two allotments.

This requirement is typically related to the master planning of land division estates and therefore applies holistically to the surrounding road network. In other words, it does not require that such a parking provision be available in front of each individual allotment but rather within a walkable precinct of a development. Notwithstanding this, if this rate was to be applied to Palmyra Terrace, then the eleven existing allotments would equate to an on-street parking requirement for six of the on-street spaces.

Therefore, while the increased density associated with the proposed development will likely result in additional visitor parking demands, there would be sufficient capacity on Palmyra Avenue (and

20-0075 5 March 2021 Page 4 of 4



indeed the adjacent street network) to accommodate these vehicles, even if no additional visitor parking is provided on site.

3.2 BICYCLE PARKING

Council's Development Plan identifies a bicycle parking requirement of one space per four dwellings for residents and one space per ten dwellings for visitors to a residential development within the Urban Corridor Zone. The proposal will provide for seven bicycle parking spaces in accordance with this requirement.

4 TRAFFIC ASSESSMENT

The proposed development will result in the construction of 17 additional dwellings when compared with the existing situation. This would equate to an additional traffic demand of approximately 140 trips per day (based on eight trips per dwelling per day), or 14 additional movements in the peak hour. This additional traffic volume is very low and will have a negligible impact on the adjacent road network.

5 SUMMARY

In summary, it is proposed to develop 5-9 Palmyra Avenue, Torrensville to provide 19 residential dwellings. The proposed parking and internal road network will comply with the requirements of the relevant Australian/New Zealand Standard. The internal road layout will allow drivers to turn on site and therefore enter and exit the site in a forward direction.

Provision has been made for the storage of refuse associated with the internal units and collection by a private contractor.

The development will provide sufficient on-site parking for residents but includes a generous landscaped area in lieu of provide additional parking spaces on site for visitors. There would be limited impact on the adjacent road network as a result of this, given the capacity for on-street parking on Palmyra Avenue and nearby roads.

The additional traffic generated by the proposal will be minimal and, therefore, will not change the nature or function of the adjacent road network.

Yours sincerely,

MFY PTY LTD

JAYNE LOVELL Senior Associate

SOLVANO TRASHIC PUZZLES PUR 40 YEARS

Palmyra St Torrensville

	Botanical Name	Common Name	Number	Size
Aae	Adiantum aethiopicum	Maidenhair Fern	14	140
Abl	Asplenium bulbiferum	Birds Nest Fern	2	140
Abu	Anigozanthos 'Bush Gold'	Dwarf yellow Kangaroo Paw	120	140
Aca	Ajuga Çaitlin's Giant'	Bugle Flower	14	140
Ala	Acacia lanigera	woolly wattle	9	140
Alí	Alternanthera 'Little Ruby'	Alternanthera	40	140
Amo	Acanthus mollis	Bears Breeches	36	140
And	Alocasia odora	Elephants Ears	6	200
Bgi	Blechnum 'Silver Lady'	Silver Lady Fern	12	140
Bsc	BergeniaxSchmidtii	Bergenia	14	140
Cfi	Corymbia ficifolia c.v.	Dwarf Grafted Flowering Gum	19	300
Cfr	Cordyline fruiticosa Rubra	Cordyline	6	140
cja	Camellia Japonica	camellia	2	200
cmi	clivia miniata	clivia	6	140
Dan	Dicksonia antarctica	Soft Tree Fern	2	200
DMa	Dracaena marginata	Dracaena	6	200
Dre	Dichondra repens	Kidney Weed	56	140
Eni	Eremophila nivea	Native Fuchsia	31	140
Hou	Hibbertia cuneiformis	Cut Leaf Guinea Flower	16	140
Hma	Hydrangea macrophylla	Hydrangea	2	200
Hgo	Hymenosporum 'Gold Nugget'	Dwarf Native Frangipani	40	140
Lli	Lomandra 'Little Lime'	Matt Rush	131	140
Llo	Lomandra 'Lime Tuff'	lily Turf	327	140
Llt	Lomandra longifolia	Matt Rush	24	140
Lsi	Liriope 'Silver Lawn'	Lily Turf	36	140
мра	Myoporum parvifolium	Creeping Boobialla	4	140

		Total	1218	
Wst	Wahlenbergia stricta	Australian Bluebell	14	140
Vhe	Viola hederaceae	Native violet	20	140
Spu	Scaevola 'Purple Dancer'	Fan Flower	149	140
RCO	Raphiolepis 'Cosmic White'	Indian Hawthorn	40	140
PVÍ	Physostegia virginiana	Obedient Plant	2	140
Pve	Plectranthus verticillus	Swedish Ivy	6	140
Plí	Philodendron 'Little Phil'	Dwarf Philodendron	6	200
Nmo	Nandina 'Moonbay'	Dwarf Sacred Bamboo	6	200

STATEMENT OF REPRESENTATION

Pursuant to Section 38 of the Development Act 1993

TO

Chief Executive Officer City of West Torrens 165 Sir Donald Bradman Drive HILTON 5033

RECEIVED - CWT IM 6 SEP 2021

DEVELOPMENT No.


211/279/2021

PROPERTY ADDRESS:

5 Palmyra Avenue, TORRENSVILLE SA 5031, 7-9 Palmyra Avenue, TORRENSVILLE SA 5031

VOUD EIII 1 11445E	
YOUR FULL NAME	Quy Phuoc Lam 4 Rawlings Avenue, Torrensuille SA
YOUR ADDRESS	4 Rawlings Avenue, Torrensuille SA
	5031
YOUR PHONE No	303(
YOUR EMAIL	
NATURE OF	owner of land in the vicinity
INTEREST	J
REASON/S FOR REF	(eg. Adjoining resident, owner of land in the vicinity etc.)
The beleases	facina Palmura Ave will be overlooking
Dailong's	facing Palmyra Are will be overlooking timenty troom, kitchen.
the backyard,	tiving, Irooin, kitchen.
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and for over	- looking windows to be made of pamel away
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	ropriate box below whether or not you wish to be heard by Council in respect to this
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DATE 4/9/21	
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	Degrapaible Officers Brandon Founter

Responsible Officer: Brendan Fewster Ends: Monday 6 September 2021

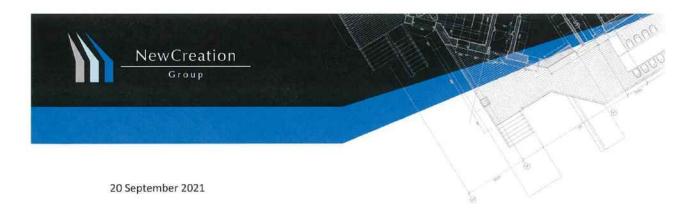

Brendan Fewster
Responsible Officer
City of West Torrens
165 Sir Donald Bradman Drive
HILTON SA 5033

Development Application: 211/279/2021

Location: 5 Palmyra Avenue Torrensville

7-9 Palmyra Avenue Torrensville
Proposed Development: Demolish of existing building and construction of 19 two storey

dwellings with common driveway access and associated

landscaping

Response To Representation Received To Above Application

"Some concerns for this development. I would like to know then plans for following when
considering any speed limits around exit for pedestrian safety (e.g. kids) any traffic control e.g.
visitor parking limits on street, in particular peak hours and bin collection days. (Thursday) since
Palmyra Avenue is a narrowing road, any noise control for busy traffic on weekends"

M Lu - 4 Blanden Ave Marden SA 5070

Applicants Response

Traffic Control & Pedestrian Safety

It is proposed to redevelop the site with a group dwelling consisting of 19 three-bedroom residences, each with a double garage. The dwellings will be accessed via a two-way circulation roadway on the western side of the site. This will allow all drivers to be able to enter and exit the site in a forward direction.

Pedestrian safety has been addressed in this application by MFY Consultants. At the exit point of the proposed driveway to Palmyra Avenue, the pedestrian site triangle is 2.0m x 2.5m and complies with the Australian/New Zealand Standards. Landscaping and fencing in this area will be low profile, and allow for clear visibility for pedestrians, cyclists and road users.

Speed limits

Palmyra Avenue is a local residential road under the care, control and management of Council. Speed limits are not part of this development application; all road users need to comply with current 50km p/h speed limit.

Development | Commercial | Designer Homes | Additions | Renovations |

New Creation Group Pty Ltd ABN 61 118 245 891 BLD No. 195500 309 North East Road Hampstead Gardens SA 5086 HIA Member 922938 P 08 8367 5111 F 08 8367 5333

E info@newcreationgroup.com.au www.newcreationgroup.com.au

Onsite Parking Provision

Council's Development Plan identifies the following parking requirement within the Urban Corridor Zone:

- two spaces per three-bedroom dwelling; plus
- 0.25 spaces per dwelling for visitors.

The 19 three-bedroom residence each with double garages will satisfy the requirement for two residential parking spaces per dwelling.

In addition, there are two parallel visitors parking spaces along the western edge of the central landscaped area.

Offsite Parking Provision

Palmyra Avenue has been assessed by MFY Consultants to have an existing on-street parking provision for up to 41 vehicles.

It is anticipated occupants having double garages - 38 parks and 2 visitor parks onsite and bike rack provisions, the need for additional parking off site will be minimal, however capacity is available.

Traffic Movements

The proposed development will result in the construction of 17 additional dwellings when compared with the existing situation.

This would equate to an additional traffic demand of approximately 140 trips per day (based on eight trips per dwelling per day), or 14 additional movements in the peak hour. MFY Consultants have assessed additional traffic volume as very low and will have a negligible impact on the adjacent road network.

Waste Management & Collection

External dwelling facing Palmyra Avenue will access refuse collection services from Council on their scheduled collect i.e. Thursday.

Internal dwellings will be required to arrange a private refuse collection from a suitably licensed private contractor. Access to internal via a swept path allowing refuse collection vehicle turn on-site and as such, drivers of such vehicles will be able to enter and exit the site in a forward direction. This will reduce obstruction and unnecessary congestion on Palmyra Avenue.

It is highly recommended that refuse collection days/times for internal and external dwellings should be staggered.

Below photo on refuse collection day, showing clear access on Palmyra Ave, capacity for external unit refuse collection and visitor parking.



Reason for Representation

"The balconies facing Palmyra Ave will be looking the backyard, living, family room, kitchen"

My Representation Would Be Overcome By

"For the overlooking balconies to be removed and for overlooking windows to be made of panel awning vision obscuring glass. The units overlooking Palmyra Avenue can be turned so the balcony overlooks the common driveway"

P Q Lam - 4 Rawlings Ave Torrensville

Applicants Response

Units 1-8 have been designed to be two storey dwellings fronting Palmyra Avenue and have been designed to have minimal impact on the street.

The finish floor level of the balconies is 3100mm. The upper-level sliding doors are setback 1300mm from the balcony façade. The balcony of all units is enclosed either side. The balustrade is framed glass to 1-meter-high.

See below photo of the corner property located at no. 4 Rawlings Ave Torrensville, showing two storey dwelling facing Rawlings Ave and a freestanding garage facing Palmyra Ave.

Based on the unit 1-8 balconies finish floor height, front angle of viewing and location of existing freestanding garage it would be impossible for any person standing on the balcony to overlook any rear yards in Palmyra Ave or Rawlings Ave Torrensville.

The option to apply obscuring glazing to proposed sliding door/windows would not make any difference and only reduce the light and liveability of the master bedroom area for occupants.



In addition, Palmyra Avenue has large council street trees, including

- Callistemon (Bottlebrushes) a medium and large shrub to 6m -10m high see above photo
- Jacaranda Mimosifolia (Jacarandas) a large tree can reach a height of around 10-15m and spread
 of the same size see below photo

There is currently 5 mature Bottlebrushes in front of the proposed 1-8 units and scheduled to remain in situ. These large trees and scrubs provide a perfect green break and privacy screen between dwellings. This will again reduce any overlooking or privacy concerns for residents



Incorporated in this application is a landscaping plan for common areas and individual units, by Living Picture Consultants. This plan includes a range trees, scrubs and grasses with varying height, density and colouring to soften each dwelling façade and increase privacy and wellness for both occupant and residents.



Summary

It is proposed to develop 5-9 Palmyra Avenue, Torrensville to provide 19 residential dwellings.

The proposed parking and internal road network will comply with the requirements of the relevant Australian/New Zealand Standard.

The internal road layout will allow drivers to turn on site and therefore enter and exit the site in a forward direction.

Provision has been made for the storage of refuse associated with the internal units and collection by a private contractor.

The development will provide sufficient on-site parking for residents but includes a generous landscaped area.

There would be limited impact on the adjacent road network as a result of this, given the capacity for on-street parking on Palmyra Avenue and nearby roads.

The additional traffic generated by the proposal will be minimal and, therefore, will not change the nature or function of the adjacent road network.

If you require any further details, please let know.

Charles Thompson New Creation Group

Thank ye

E. Charles@newcreationgroup.com.au

Preliminary Traffic, Flooding & Stormwater Assessment

Development Application No: 211/279/2021

Assessing Officer: Brendan Fewster

Site Address: 5 Palmyra Avenue, TORRENSVILLE SA 5031, 7-9

Palmyra Avenue, TORRENSVILLE SA 5031

Certificate of Title: CT-5720/72, CT-5798/608

Description ofDemolition of existing buildings and construction of 19
two-storey dwellings with common driveway access

and associated landscaping

TO THE TECHNICAL OFFICER - CITY ASSETS

Please	provide your comments in relation to:					
	Site drainage and stormwater disposal					
	Required FFL					
	On-site vehicle parking and manoeuvrability					
	New Crossover					
	Your advice is also sought on other aspects of the proposal as follows:					
PLANI	NING OFFICER - Brendan Fewster DATE 24 August, 2021					



Memo

To Brendan Fewster

From Richard Tan
Date 24-Aug-2021

Subject 211/279/2021, 5 Palmyra Avenue, TORRENSVILLE SA 5031, 7-9 Palmyra

Avenue, TORRENSVILLE SA 5031

Brendan Fewster,

The following City Assets Department comments are provided with regards to the assessment of the above development application:

1.0 FFL Consideration – Finished Floor Level (FFL) Requirement

1.1 In accordance with the provided 'Civil & Drainage Plan' (KP, Ref: 210209-C2-A, dated 17/2/21) the FFLs of the proposed development (99.60 minimum) have been assessed as satisfying minimum requirements (99.38 minimum) in consideration of street and/or flood level information.

2.0 Verge Interaction

2.1 In association with new development, driveways and stormwater connections through the road verge need to be located and shaped such that they appropriately interact with and accommodate existing verge features in front of the subject and adjacent properties. Any new driveway access shall be constructed as near as practicable to 90 degrees to the kerb alignment (unless specifically approved otherwise) and must be situated wholly within the property frontage.

New driveways and stormwater connections are typically desired to be located a minimum 1.0 metre offset from other existing or proposed driveways, stormwater connections, stobie poles, street lights, side entry pits and pram ramps, etc. (as measured at the front property boundary). An absolute minimum offset of 0.5m from new crossovers and stormwater connections to other existing road verge elements is acceptable in cases where space is limited.

These new features are also desired to be located a minimum of 2.0 metres from existing street trees, although a lesser offset may be acceptable in some circumstances. If an offset less than the desired 2.0 metres is proposed or if it is requested for the street tree to be

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removed, then assessment for the suitability of such will be necessary from Council's Technical Officer (Arboriculture).

2.1.1 Stormwater connection is in direct conflict with the common crossover servicing multiple dwellings at the rear.

It is recommended that a civil plan indicating offset of features satisfaction to the above requirements should be provided to Council.

2.1.2 The proposed crossover is in direct conflict with an existing street tree. Council's Arboriculture Team has supported the removal of the existing street tree in direct conflict with the proposed crossover. However, there seems to be typo in their assessment, as highlighted in the following:

A site investigation together with the information provided has revealed that the location of the proposed crossover for proposed development at 5 Palmyra Avenue will directly impact an existing Callistemon viminalis (Weeping bottlebrush) street tree located 5.0m from eastern boundary.

In this instance City Operations will support the removal of the existing street tree leaving 9.5m to accommodate the proposed crossover, while allowing for a 2.0m clearance from Callistemon located 11.5m adjacent proposed residence 1.

I believed that the 'eastern' is a typo of 'western'. I leave this to the planner's consideration on whether clarification with the Arboriculture team is required.

2.1.3 No further assessment provided. Item still considered outstanding.

The stormwater connection for Residence 5 and Residence 7 should be relocated to ensure that 2m offset from existing street tree

It is recommended that revised plans indicating satisfaction to the above requirements should be provided to Council.

- 2.2 The shape and material of stormwater connection through the road verge area has been assessed as satisfying minimum requirements
- **2.3** The redundant kerb has been indicated to be reinstated on provided plans.

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3.0 Traffic Requirements

The following comments have been provided by Council's Traffic Consultant, Mr Frank Siow:

I refer to the above residential development on the subject site. The subject site is located within the Urban Corridor Zone Transit Living Policy Area 36 of the Development Plan.

The proposal is described in the application as the construction of 4 residential flat buildings comprising of 19 two-storey dwellings. Each dwelling would have 3 bedrooms and a double garage. There are no visitor parking spaces proposed on-site. The dwellings would be serviced by a common driveway with access to Palmyra Avenue to be located at the western boundary of the subject site. I understand private refuse trucks would collect bins on-site.

I note that Palmyra Avenue has a varying carriageway width. Adjacent to the subject site, on-street parking is permitted on both sides of the street.

3.1 Parking Assessment

The relevant parking rates for residential developments in this Policy Area are as follows:

- 2 spaces per 3+ bedroom dwelling
- 0.25 spaces per dwelling for visitors

The resident parking requirement would be satisfied by the provision of 2 garage spaces per dwelling. However there would be a parking shortfall of 4 to 5 spaces for visitor parking.

I note that there is a fairly large landscaped area proposed within a central garden area, which I understand forms part of stormwater detention for the site. However, given the significant distance visitors have to walk to reach the rear dwellings, if they are parked on the street, it would be desirable, in my opinion, to provide say 2 visitor spaces within the site. This would result in some loss of landscaping in the central garden area. (Note from City Assets: a permeable pavement parking would retained landscaping and at the same time provide visitor parking space)

The remaining visitor parking demand can be suitably accommodated by on-street parking. I note that the subject frontage of the site can satisfactorily accommodate 6 or more on-street parking spaces, as the

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8 dwellings that front Palmyra Avenue are designed with rear garage access.

The 10 bike parking racks shown around the central garden area would satisfy the Development Plan requirement. However, in my opinion, it would be likely that residents would park their bicycles inside their own dwelling.

3.2 Parking Layout


Previously Council's Traffic Consultant has advised that the roller doors should be widened to 5.2m to enable satisfactory access. However, I noticed that some of the dwelling (ie: Unit 9) will not have sufficient width as some allowance has been used for a personal access door next to the garage door. In this case, I leave this to the planner's consideration on whether this is acceptable or not. If this is not acceptable, then further consideration such as widened the internal road may be required. The following comments provided earlier has been reattached for information:

I note that each of the garage space is shown with a storage shelf on one side or space for shelving or walkway on one side. The proposed roller doors are 4.8m wide.

My assessment indicates that the any storage shelving would likely impact on the ability of the vehicles to access the garage spaces. In addition, the proposed roller doors should be widened to say 5.2m to enable satisfactory access to the provided (see below). I recommend that both amendments described previously be adopted to ensure that satisfactory access is provided.

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The following has been attached for information only:


While I leave the comment about refuse collection to others, I note that the internal roadway layout would allow the refuse truck to turnaround (after bin collection) to leave the site in a forward direction. At Palmyra Avenue, the refuse truck should be able to undertake the required exit turn, provided some parking prohibitions are implemented to keep potential parked vehicles away from the swept path requirement (see diagram below).

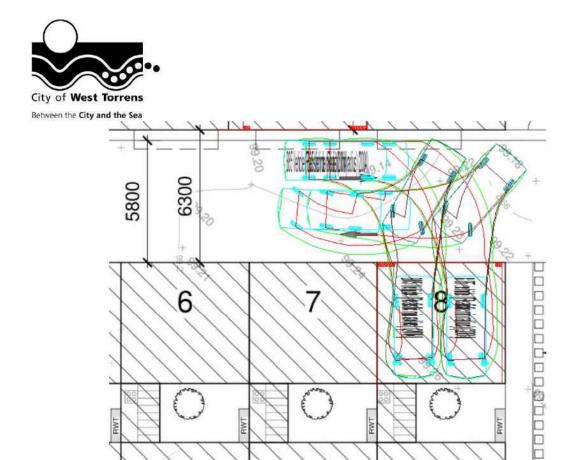This may not necessarily reduce the on-street parking for the neighbouring property to the west of the subject site, as the current kerb space would only allow one vehicle to park and the parking position would merely be shifted west. On the opposite side, there is an existing crossover to assist in the truck turn, however, additional parking prohibition may need to be extended east of the crossover. These amendments to the parking controls can be reviewed by City Assets once the development is completed.

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The proposed residential land use would be a low traffic generator. I do not have concerns with the traffic impact of the development on the adjacent road network.

The following comments have been provided by City Assets Department:

- 3.3 As the access driveway will service more than one property at the rear, the driveway corridor to the site will require widening to a minimum of 5.5m wide pavement width (+ 300mm offset from fences/walls/boundary) for the first 5.0m into the site to permit the passing of entering and exiting traffic. The proposed driveway has been assessed as satisfying minimum requirements.
- 3.4 No further assessment provided. Item still considered outstanding.

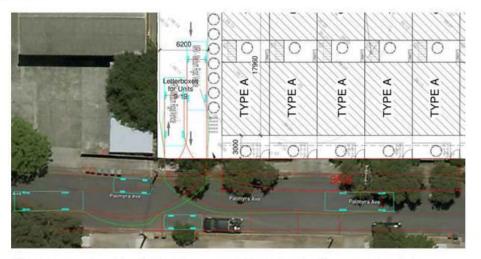It is recommended that the width of the crossover servicing multiple unit is 5.5m with 0.3m flaring on each side (6.1m wide at the kerb line).

It is recommended that revised plans showing a 5.5m crossover with 0.3m flaring on each side (6.1m wide at the kerb line) be provided to Council.

3.5 It is also important to ensure that the functionality of this driveway entrance and passing area is not compromised by the ultimate installation of letterboxes, above ground service metres or similar.

Letter boxes and services are currently located outside the driveway passing area.

It is also recommended that any approval associated with this development included a condition of similar wording to the following;

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"No aboveground structure(s) such as letterboxes, service meters or similar are to be installed within the common driveway entrance and passing area."

3.6 No further assessment provided. Item still considered outstanding.

The internal garage length is currently proposed as 5.6m. Although not specified in the relevant Australian Standards (AS/NZS 2890.1:2004), traffic engineering best practice guides that the minimum internal length of an enclosed garage or enclosed carport space should be a minimum of 5.8m.

It is recommended that revised plans be submitted, showing garage internal dimensions are stated above.

4.0 Waste Management

4.1 Due to the nature of this application, it is recommended that further assessment from Council's Waste Management Team is required.

It is recommended that further assessment from Council's Waste Management Team is required.

5.0 Stormwater Management

5.1 Stormwater Detention

Provided information, 'Civil & Drainage Plan' (KP, Ref: 210209-C2-B, dated 28/7/21) would indicated that the applicant has chosen to adopt the 'Alternate' approach for desired stormwater management for this site.

This approach providing a good consideration of stormwater detention, stormwater volume reduction, stormwater quality improvement and stormwater re-use within each dwelling.

However, the detailing of the alternate approach is not accurate. I leave this to the planner to decide whether to condition the detailing as a condition or have the applicant to amend the plans to include the accurate detailing as following:

It is recommended that any approval associated with this development included a condition of similar wording to the following;

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- All stormwater management measures for a dwelling, including harvest tanks and supply mechanisms, must be installed and operation prior to occupancy of that dwelling.
- Rainwater tank plumbed to deliver recycled water to all toilets and laundry cold water outlet. (Can also be connected to Hot Water Service if desired).
- A minimum of 90 percent of the roof area of each dwelling must be plumbed to direct stormwater runoff to the rainwater tank for that dwelling.

5.2 Stormwater Quality

As the applicant adopted the 'alternate' stormwater management as per dot point 5.1, then City Assets will support basic stormwater quality devices (such as pit filter) to be installed to reduce stormwater pollutants from the stormwater flow exiting the site. Under this context, the applicant has proposed a GPT as the proprietary product and hence the stormwater quality for the site has been considered as satisfying requirements.

5.3 Other

No further assessment provided. Item still considered outstanding. The provided stormwater layout plan has indicated that each dwelling has their own stormwater pipe discharging from the property to the pit located at Palmyra Avenue. This arrangement is quite unique and potentially not construction/cost friendly. A simple substitution (such as connecting pipes to a pit and then adopt a larger diameter pipe) can be achieved to replace this arrangement.

It is recommended that the applicant reviewed the stormwater system and provide an alternate solution to current proposal.

Regards Richard Tan Civil Engineer

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Arboricultural Assessment of Street Trees

Development Application No: 211/279/2021

REFERRAL DUE DATE:

Assessing Officer: Brendan Fewster

Site Address: 5 Palmyra Avenue, TORRENSVILLE SA 5031, 7-9

Palmyra Avenue, TORRENSVILLE SA 5031

Certificate of Title: CT-5720/72, CT-5798/608

Description of Development Demolition of existing dwellings and structures

and construction of four (4) residential flat buildings containing nineteen (19) two storey

dwellings

TO THE TECHNICAL OFFICER - CITY ASSETS

Please provide your comments in relation to:

The removal of or impact upon the Street Tree
Species of Tree:
Your advice is also sought on other aspects of the proposal as follows:

PLANNING OFFICER - Brendan Fewster DATE 17 March 2021

FROM THE TECHNICAL OFFICER

I have examined the plans as requested and provide comments as follow.

As with all development applications it must be proven beyond reasonable doubt that all alternatives have been explored so not to hinder the progress of any street tree(s).

Any proposed development that does not consider "AS4970 Protection of Trees on Development Sites", is likely to require revision until all plans accurately correspond with the specific tree information detailed in this standard.

Verge interaction must consider all services that cross council land including stormwater outlets (and other) which will need to be maintained a minimum of 2.0m from any existing street tree (unless existing or otherwise negotiated). All services must be indicated /documented on appropriate plans for Council assessment and approval.

A site investigation together with the information provided has revealed that the location of the proposed crossover for proposed development at 5 Palmyra Avenue will directly impact an existing *Callistemon viminalis* (Weeping bottlebrush) street tree located 5.0m from eastern boundary.

In this instance City Operations will support the removal of the existing street tree leaving 9.5m to accommodate the proposed crossover, while allowing for a 2.0m clearance from *Callistemon* located 11.5m adjacent proposed residence 1.

With reference to the City of West Torrens, Fees and Charges Document 2020-2021 "Tree removal for driveway construction", once Council has assessed all circumstances and considered it acceptable that a street tree can be removed, a fee is calculated based on Council's standard schedule of fees and charges.

The fee is used to offsets the loss of the asset (street tree) to the community, with funds received invested in Council's annual Greening Program.

As a result of the proposed crossover for proposed development 5 Palmyra Avenue, City Operations has considered the health, structure, form, useful life expectancy and age of the street tree and in this instance will support the removal.

A fee of \$ 750.00 will be required prior to the commencement of any work.

Please note, under no circumstances is any individuals other than council staff permitted to interfere with a street tree. If pruning etc. is required, council must be notified via the appropriate customer request, and council staff will perform all works associated with the community asset.


Final crossover locations will be confirmed once appropriate documentation has been received from the applicant and they have submitted "an application to construct a vehicle crossing place(s) across council land".


Raoul Brideoake Technical Support Officer Arboriculture (Acting) 165 Sir Donald Bradman Drive Hilton SA 5033


Telephone: 8416 6333


Fax: 8443 5709


DATE: 24/03/2021

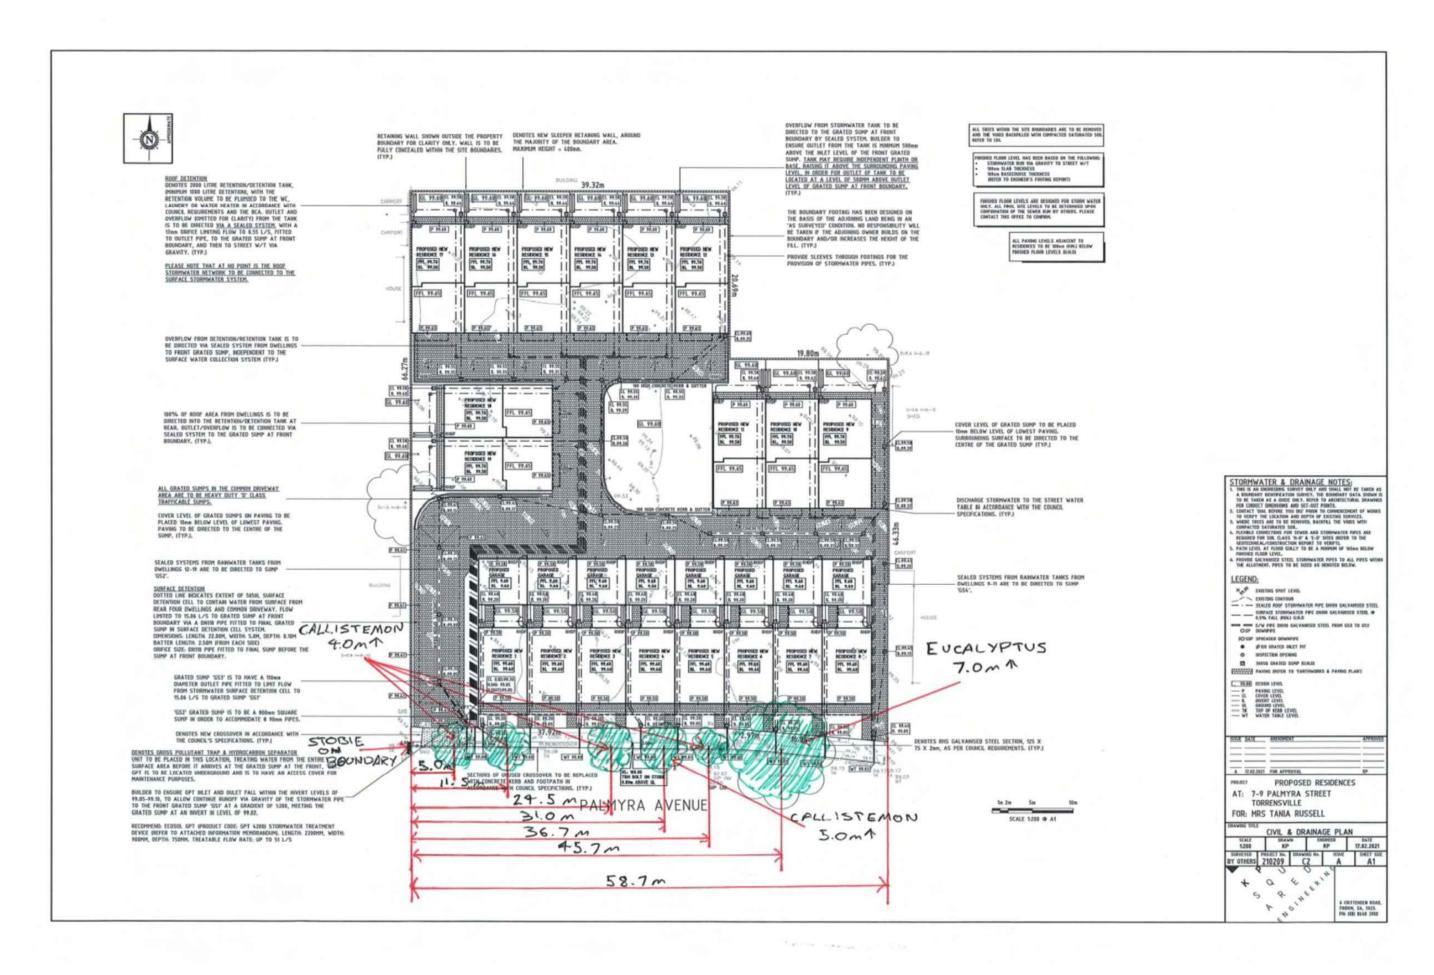


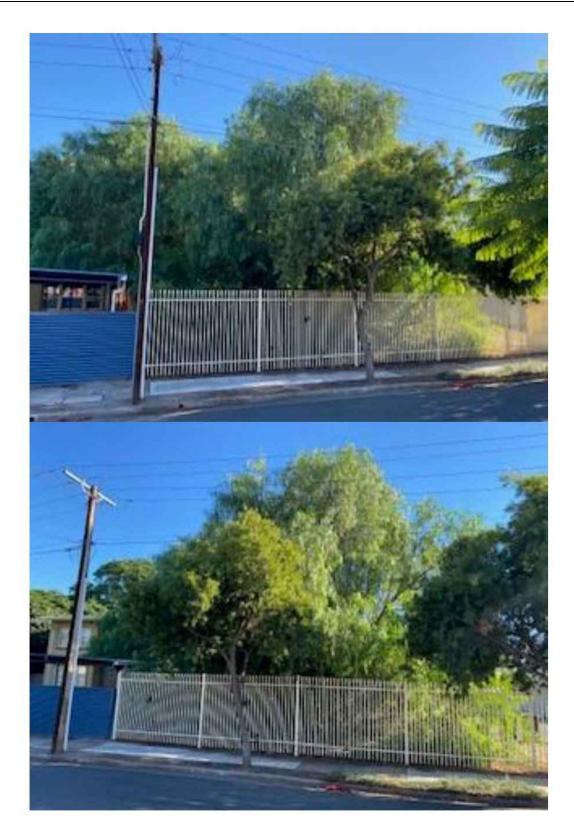

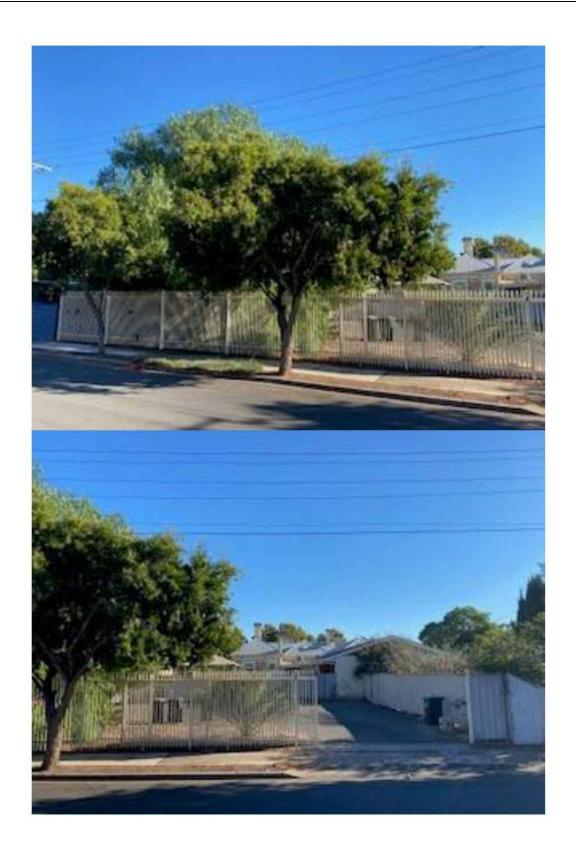

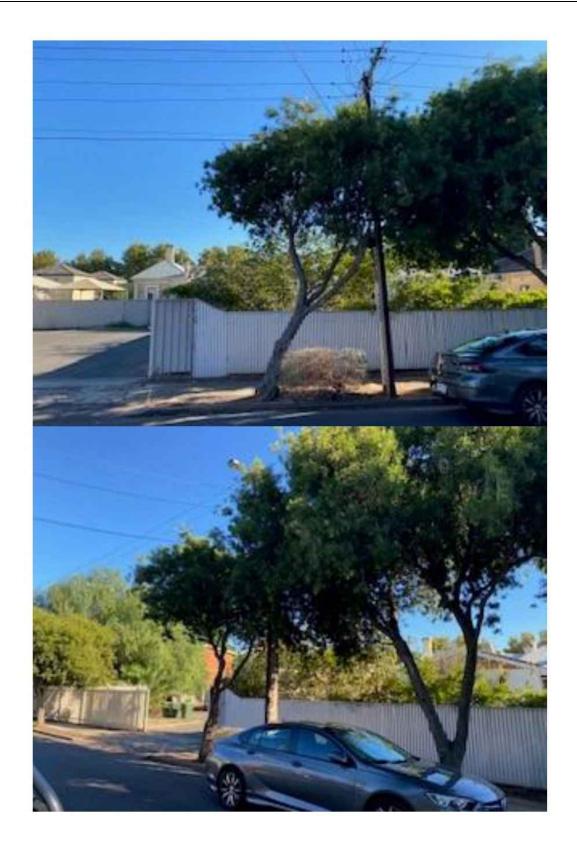

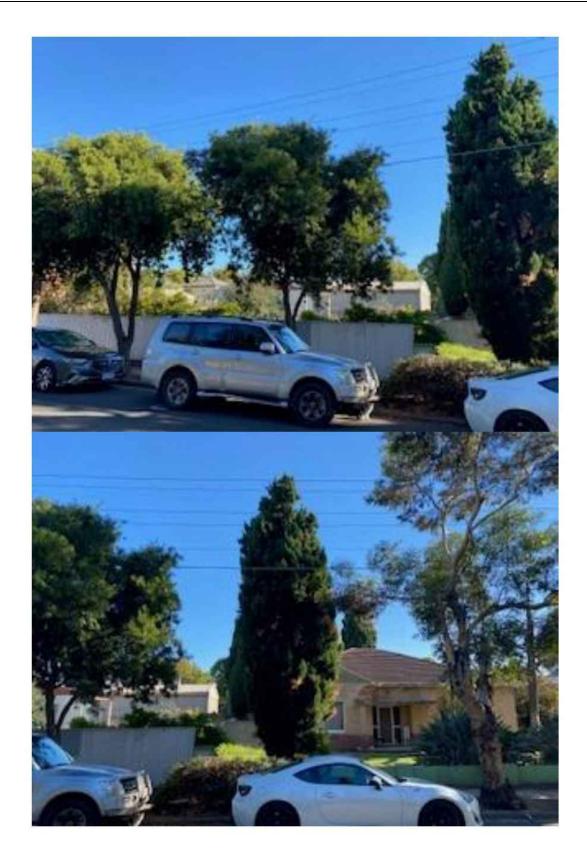

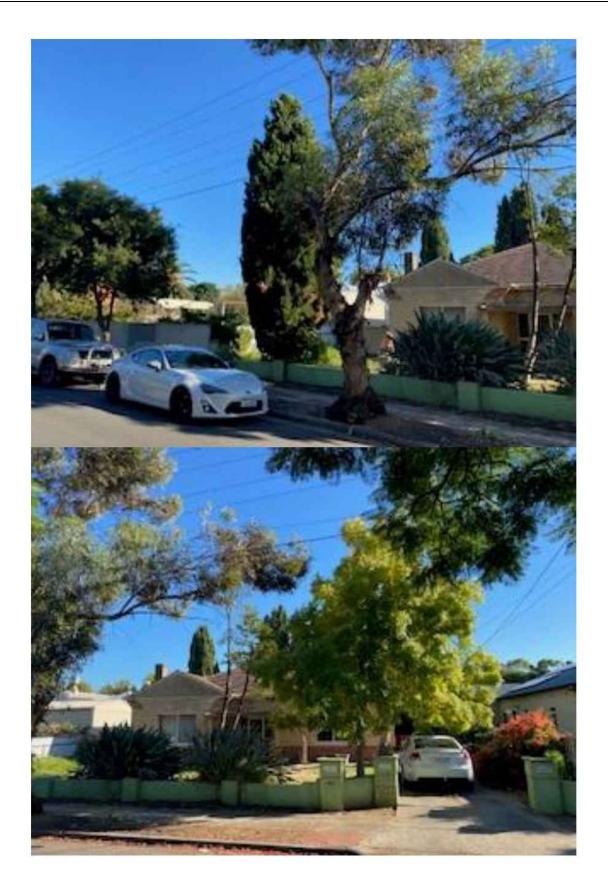





Waste Management Assessment

Development	Application No:	211/279/2021
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Assessing Officer: Brendan Fewster

Please provide your comments in relation to:

Site Address: 5 Palmyra Avenue, TORRENSVILLE SA 5031, 7-9

Palmyra Avenue, TORRENSVILLE SA 5031

Certificate of Title: CT-5720/72, CT-5798/608

Description ofDemolition of existing dwellings and structures and**Development**construction of four (4) residential flat buildings

containing nineteen (19) two storey dwellings

TO TEAM LEADER WASTE MANAGEMENT - REGULATORY SERVICES

Any aspect that you feel needs further attention or detail



Memo

To Brendan Fewster

From Nick Teoh
Date 23-Mar-2021

Subject 211/279/2021 5 Palmyra Avenue, TORRENSVILLE SA 5031, 7-9 Palmyra

Avenue, TORRENSVILLE SA 5031

Dear Brendan Fewster

The following Waste Management comments are provided with regards to the assessment of the above develop application:

Waste Management

The proposed development at 5 and 7-9 Palmyra Avenue, Torrensville exceeds the maximum number of bins (10) for a standard or shared Council waste service. The proposal outlined by MFY Pty Ltd meets the requirements for waste provision to residential dwellings through a commercial waste company.

Kind regards

Nick Teoh Team Leader Waste Management

6.2 PDI ACT APPLICATIONS

Nil

7 REVIEW OF ASSESSMENT MANAGER DECISION

Nil

8 CONFIDENTIAL REPORTS OF THE ASSESSMENT MANAGER

Nil

9 RELEVANT AUTHORITY ACTIVITIES REPORT

9.1 Activities Summary - November 2021

Brief

This report presents information in relation to:

- 1. Any development appeals before the Environment, Resources and Development (ERD) Court where the Council Assessment Panel (CAP) is the relevant authority;
- 2. Other appeal matters before the ERD Court of which SCAP are the relevant authority;
- 3. Any deferred items previously considered by the CAP
- 4. Summary of applications that have been determined under delegated authority where CAP is the relevant authority; and
- 5. Any matters being determined by the State Commission Assessment Panel (SCAP).

RECOMMENDATION

The Council Assessment Panel receive and note the information.

Development Application appeals before the ERD Court

CAP is the relevant authority

Nil

SCAP is the relevant authority							
DA number	Address	Description of development	Status				
211/M022/17	79 Port Road, THEBARTON	Multi-storey mixed use development, incorporating commercial tenancy, 2 storey car park, 9-storey residential flat building, four x 3-storey residential flat buildings and car parking	Compromise plans have been received and Council comments provided to SCAP 09 November 2020. The compromise proposal was scheduled for conciliation conference 28 January 2021. No further update available.				

Deferred CAP Items

Nil

Development Applications determined under delegation (CAP is the relevant authority)

Awaiting PlanSA Portal functionality to report on relevant applications.

Development Applications pending determination by SCAP

DA Number	Reason for referral	Address	Description of development
21016709	Schedule 6	1A-1B Glenburnie Terrace Plympton	Seven storey residential flat building comprising 32 dwellings with associated carparking and landscaping Council comments sent to SCAP. Further information has been requested by ODASA.
211/M135/21	Schedule 10	1 Colby Ctroot Kurrolto	·
Lodged 16/03/21	Schedule 10	1 Selby Street, Kurralta Park	Construction of a 10-storey residential flat building with associated car parking and site works.
			Under Assessment
211/M134/21 Lodged 16/03/21	Schedule 10	4-10 Railway Terrace Mile End	Construction of a mixed use residential/commercial development comprising 51m² commercial tenancy, two (2) residential flat buildings comprising 6 dwellings and 28 dwellings associated landscaping, carparking, communal spaces and public realm improvements (Stage 2) Under Assessment Public notification is being undertaken - closes 10 November
			Council comments due 1 December
			2021 - City Assets currently reviewing

DA Number	Reason for referral	Address	Description of development
211/M129/21 Lodged 17/02/21	Schedule 10	8 Eton Road, Keswick	Construction of a six (6) storey mixed use building comprising residential and commercial tenancies together with car parking and landscaping. Under Assessment Council comments sent to SCAP on 18/03/21

Conclusion

This report is current as at 1 November 2021.

Attachments

Nil

10 OTHER BUSINESS

11 MEETING CLOSE